

TOWN OF HERNDON, VIRGINIA

ORDINANCE

DECEMBER 13, 2022

Ordinance- to approve DP #21-01, 555 Herndon Parkway, a development plan in the Planned Development-Transit Oriented Core Zoning District with proffered conditions, to allow redevelopment of the site with mixed office, retail, and multi-family residential uses.

In adopting this Ordinance, the Town Council has considered the factors set out in 15.2-2284, Code of Virginia (1950) as amended.

BE IT ORDAINED by the Town Council of the Town of Herndon, Virginia that:

- A. The zoning of the property described below, lying in the Town of Herndon, Fairfax County, Virginia, is amended to allow mixed office, retail, and residential use with zoning ordinance modifications as proposed in the 555 Herndon LLC, C/O Penzance Management, LLC Generalized Development Plan dated December 5, 2022, and the Proffer Statement dated December 13, 2022, of DP #21-01, and in accordance with Section 78-50.8 and 78-155.1 of the Town of Herndon Zoning Ordinance.

The property is shown in the above referenced Generalized Development Plan and described in the land records of Fairfax County in Deed Book 5838 on Page 1680. The Fairfax County Tax Map Number is 0164-10-0002C and the total land area is 4.34 acres.

- B. This rezoning shall be governed by this ordinance, the Town of Herndon Zoning Ordinance, the above referenced Proffer Statement for DP #21-01, and the above referenced Generalized Development Plan for DP #21-01. The Proffer Statement is included as an attachment to this ordinance. This Development Plan is consistent with the adopted 2030 Comprehensive Plan of the Town of Herndon.
- C. The Town Council approves the following modifications to the zoning regulations, as allowed under Section 78-50.2(d):
 - i. A modification to Section 78-100.2(d) to allow a reduction in the number of required loading spaces.

- ii. A modification to Section 78-100.6(a) to allow a reduction in the minimum width of loading spaces.
 - iii. A modification to Section 78-50.8(h) to allow a deviation from the streetscape dimensional criteria of the Herndon Streetscape Manual.
- D. As to the modifications set out in item C. above, the Town Council finds that such modifications will afford equal or greater assurance of meeting the goals of the zoning ordinance, Town of Herndon, Virginia, as set out in the preamble of that ordinance.
- E. This ordinance shall be effective on and after its adoption.

This is certified to be a true and accurate copy of Ordinance 22-O-28 adopted at a legally convened meeting of the Town Council of the Town of Herndon on December 13, 2022.

Margie C. Tacci, Deputy Town Clerk

1879

Attached are the Proffer Statement dated December 13, 2022 and the 555 Herndon LLC, C/O Penzance Management, LLC Generalized Development Plan dated December 5, 2022.

PROFFERS

555 Herndon Parkway DPA/PCA

**13
December 07, 2022**

Pursuant to Section 15.2-2303 of the Code of Virginia (1950, as amended) and Section 78-50.8 of the Town of Herndon Zoning Ordinance, as amended (the "Zoning Ordinance"), the undersigned, for themselves and their successors and/or assigns (referred to hereafter, both collectively and, where appropriate, individually, as the "Applicant"), hereby proffers that the development (the "Development") of the parcel that is the subject of this application, which is shown on the Fairfax County 2022 Tax Map as parcel 016-4 ((10)) 0002C (the "Property") shall be in substantial conformance with the conditions set forth below (the "Proffers") if and only if Development Plan # 21-01 ("Development Plan") is approved. Upon approval, these Proffers will supersede any and all previously approved proffers and development conditions associated with DP# 17-01 and subsequent amendments, as they apply to the Property.

1. DEVELOPMENT PLAN.

- a. The Property shall be developed in substantial conformance with the development plan entitled 555 Herndon Parkway prepared by Christopher Consultants and Davis Carter Scott dated December 05, 2022 (the "Development Plan") and these Proffers. It is understood by the Applicant that all other applicable regulations and policies governing land development within the Town of Herndon (the "Town") shall apply to the Property and its development unless specifically modified by the language of this approval.
- b. Minor modifications of the Development Plan may be permitted without the need for an amendment to this approval when necessitated by final engineering or site design provided that the development is in substantial conformance with the Development Plan, these Proffers, and as approved by the Architectural Review Board ("ARB"), if applicable. Substantial conformity shall be determined as provided in the Zoning Ordinance.
- c. The Applicant may proceed with the approval of a unified commercial subdivision development plan without the need to amend these Proffers, provided that the proposed subdivision does not adversely impact the ability of the site to develop in accordance with the Development Plan and these proffers.

2. ARCHITECTURE AND URBAN DESIGN

- a. The final architectural treatment and exterior design of all buildings within the Development Plan shall create a sense of identity and place through the use of unifying elements such as materials, textures, color, lighting, and landscaping as generally reflected on the materials and exhibits contained in the Development Plan and the HTOC Urban Design & Architectural Guidelines.
- b. Architectural plans may be revised in accordance with ARB review and approval subsequent to the final approval of the Development Plan.
- c. **Development Phasing.** The Applicant shall construct the streets and provide pedestrian improvements, public accessible parks, private amenities and public accessible facilities on the Property in conjunction with the development of each development phase in a manner that reflects the intent of that shown within the Phasing Exhibits contained in the Development Plan. Development may proceed with either the residential phase first, then the office phase, or with both phases occurring at the same time, provided that each building provides the phasing conditions depicted on the Phasing Exhibits. Each phase of the project shall also comply with the minimum parking requirements. Adjustments to the phasing boundaries may be approved with the site plan approvals provided that the adjustments do not materially adversely affect the other phases.
- d. **Conceptual Open Space Plan.** The Development Plan includes a conceptual publicly accessible open space plan for the Property as shown on Sheet 8.0 consisting of approximately 1 acre and a conceptual private open space plan as shown on Sheet 9.0 and 9.1 (alternate layout). The plans include details for streetscapes, plazas, publicly accessible open space areas, courtyards and private amenity areas. As part of each plan approval, more detailed landscape plans for each building phase shall be provided and subject to the review and approval of the ARB, provided that the detailed landscaping and hardscape plans are found to be in substantial conformance with the concepts included in the Development Plan.
 - i. **Open Space on Structured Parking.** The Development Plan includes a conceptual private open space on top of the parking structure as shown on Sheets 5.0, 5.2 (alternate layout), 9.0, and 9.1 (alternate layout). Notwithstanding Sheet 5.1, this amenity may be provided with either phase of the Project.
 - ii. **Phase 1 Interim Green Space.** The Development Plan includes a conceptual open space within the footprint of the future office building as shown on Sheet 5.1. This space will include landscaping, a dog park, bocce ball court, and seating.
- e. **First Floor Activation.** The Applicant shall include active first floor uses in the areas shown in the Development Plan facing Herndon Parkway, facing portions of the

internal open space courtyard, and along the private streets. Active first floor uses shall incorporate transparent exterior store fronts, residential and office lobbies, and residential stoops and patios accessible from the abutting streetscape or internal drop-off courtyards as depicted on the Development Plan.

- f. **Interior Noise Attenuation**. The Applicant shall submit highway noise studies, prepared by a qualified acoustical consultant, at the time of each building permit submission to determine what if any noise attenuation measures are needed to achieve Day-Night Average Sound Levels (DNL) of no more than 45 dBA for interior residential uses or hotel uses and no more than 55 dBA for interior office uses. Based on the findings of the studies, the Applicant shall incorporate the appropriate noise attenuation elements into the design and construction documents to achieve the recommended DNL for the applicable building(s) or portions thereof.
- g. **Streetscape Furnishings, Materials and Lighting**. Streetscape furnishing, materials and lighting plans shall be provided as part of the site plan and shall be in substantial conformance with the HTOC Urban Design & Architectural Guidelines and the Herndon Streetscape Manual and subject to review and approval by the ARB. Unified and high-quality streetscape materials shall be provided and may include, but not be limited to, unit pavers, seat walls, tree space edging, lighting, traffic signal poles, benches, trash receptacles and other hardscape elements. These plans submitted as part of the site plan shall include general product information and approximate locations of furnishings and materials to be located in the streetscape between the building face and the curb.
- h. **Sugarland Run Trail fence and Lighting**. The Applicant shall install a metal fence and lighting along the southern border of the Property. The style of the components shall reflect the HTOC Urban and Design and Architectural Guidelines and are subject to the review and approval of the ARB. The proposed fence and lighting shall be incorporated in the first site plan for the Property and shall be built with the first phase of the project.
- i. **Decorative Surface Treatments**. The Applicant shall utilize decorative pavers for high visibility crosswalks at all intersections. Similar crosswalks designed to blend with the adjoining streetscape pavements shall extend over aprons and curb cuts to loading docks or similar vehicular entrances and exits. Within the roadway a special decorative surface treatment or pavers shall highlight the pedestrian/vehicular entrance into the garage and/or pedestrian connections. The style of the crosswalks and special surface treatments shall reflect the HTOC Urban Design Guidelines and are subject to the review and approval of the ARB.
- j. **Design of Central Plaza and Internal Street**. The plaza will include decorative

pavers and crosswalks, flush curbs, bollards and other design elements as shown, subject to the review and final approval of the ARB. The internal street installed with Phase 1 shall include final materials including the decorative pavers within the drive aisle as shown on Sheets 6.0 and 7.0 of the development plan.

- k. **Existing Utilities Relocation.** The Applicant shall relocate, at its expense, any existing utilities (and associated easements) necessary to accommodate the proposed development as shown on the Development Plan. The relocation shall be shown at the time of site plan approval as required by the Town. Any necessary utility relocation shall occur with construction of the Development and prior to issuance of any certificate of occupancy.

- i. **Interim Design and Garage Screening.**

- i. As part of Phase 1 (residential phase), prior to construction of the office phase, the applicant shall screen the exposed portion of the garage and unfinished sides of the residential building. The screening shall be provided in the interim between Phase 1 and Phase 2, and may be made of decorative metal mesh, paint, fabric panels, landscaping, or other design treatments subject to ARB review and approval.
 1. The interim screening shall be well maintained and shall not be permitted to deteriorate over time.
 2. The interim screening shall cover a minimum of 50% of the garage openings.
 - ii. For the permanent condition, the exposed portion of the office building garage shall be treated with architectural enhancements that integrate the garage into the overall project design as shown on Development Plan Sheet 16.2.

- m. **Water Sampling Station.** The Applicant shall provide a water sampling station in the general location shown on the Development Plan. Exact location and design to be determined during Site Plan and Building Plan review.

- n. **Retail Parking.** The parking shall be located as shown on the Development Plan.
3. **USES.** Unless modified by an amendment to the approved Development Plan, any use or combination of uses permitted in the PD-TOC may be established on the Property so long as the Project is in substantial conformance with graphics and notes on Development Plan Sheet 4.0, or Sheet 4.1 (Alternative Layout) and the following:

- a. The total maximum project floor area is limited to 698,182 square feet of GFA which is a 3.69 FAR based on a lot area of 189,218 square feet.
- b. Total residential development shall not exceed 488,182 square feet of GFA;
- c. Total non-residential development shall not be less than 200,000 square feet of GFA. Non-residential uses shall be limited to the following:
 - i. Post-secondary institution
 - ii. Museum
 - iii. Library
 - iv. Community center
 - v. Conference center
 - vi. Theater
 - vii. Indoor Entertainment
 - viii. All office uses, including healthcare and outpatient healthcare facilities
- d. Total retail development shall not be less than the minimums shown on Sheet 4.0 of the Development Plan.
- e. Subject to Zoning Ordinance Article IX, Temporary uses and Structures, the Applicant, or its designee, shall be permitted to operate or hold festivals, fairs farmers' markets, food trucks/carts or similar activities on the Property, either in the interim surface parking lots or within publicly-accessible privately-owned open spaces, pedestrian ways and private streets. Portions of the private street network may be closed for such activities, provided that alternate circulation, garage and parking access is maintained.

4. TRANSPORTATION.

- a. Off-Site Transportation Improvement Contribution. The Applicant shall make a per GFA foot contribution of \$1.50 for residential square footage and \$2.50 for commercial square footage to the Town to address off-site transportation improvements. This contribution shall be paid on a pro-rata basis upon or prior to the issuance of an occupancy permit for each building based on the actual GFA of the building.
- b. Credit for Off-site Transportation Improvements. The Applicant shall receive credit towards the contribution provided in Proffer 4(a) for off-site transportation improvement expenditures requested by the town and constructed by the Applicant, except for expenditures required in Proffer 4(c) or improvements required by the

Zoning Ordinance.

- c. **Traffic Signal at Herndon Parkway and Western Property Entrance.** Prior to approval of the first site plan for Building A if the unit count exceeds 435 units, and prior to approval of the first site plan for Building B, a full traffic signal warrant analysis shall be prepared and submitted to the Town for review and approval unless the signal has already been installed by others. If warranted, for either phase, the site plan shall include a full design of the traffic signal and the Applicant shall dedicate right-of-way or grant any utility, public access, temporary construction, or grading easements, necessary to permit its construction at no cost to the Town. If warranted, for either phase, the applicant is not responsible for obtaining off-site easements, permissions, or installing the traffic signal.
- d. **Right of Way Dedication.** The Applicant shall dedicate the right-of-way along the Herndon Parkway frontage shown as Public Dedication Area on Sheet 8.1 of the Development Plan prior to the first site plan approval. The Applicant reserves future density credit from the Right-of-Way dedication in accordance with the terms and conditions of Zoning Ordinance Section 78-155.9 in affect as of the date of the approval of these Proffers.
- e. **Public Pedestrian Access Easements.**
 - i. The Applicant will grant public pedestrian access easements over the at-grade Public Accessible Space areas as shown on Sheet 8.1 of the Development Plan.
 - ii. This easement will enable the Applicant to restrict access temporarily for private events, maintenance, and for construction and staging of the various phases. The Applicant will work with the Town to establish reasonable rules and hours for use of the central plaza and courtyard areas of the Public Accessible Space.
- f. **Private Street and Utility Easements.**
 - i. The Applicant will grant public vehicular access and utility easements over the project's perimeter streets shown as Street and Utility Easement Area on Sheet 8.1 of the Development Plan.
 - ii. These easements will enable the Applicant to close the perimeter street for the construction of future phases and street maintenance.
 - iii. Prior to Town approval of the Site Plan, the Applicant shall obtain easements, and written permission for the offsite grading and temporary construction access from the immediately adjacent property owners for

installation of offsite grading, curb tie-ins and vehicular directional arrows as shown on the Applicant's Development Plan.

- iv. The Applicant will grant temporary construction and permanent street utility and public vehicular access easements to permit the future extension of the private east-west street along the Property's south, as shown on Sheet 8.1 of the Development Plan. Provided that access is maintained for the Applicant, within the Applicant's site.
- g. Sidewalk Improvements. As shown on the Development Plan, the Applicant will construct the sidewalk and bicycle track improvements along the Herndon Parkway frontage between the eastern and western Project entrances prior to the issuance of the first certificate of occupancy for the first phase of the project.
- h. Transportation Demand Management. This Proffer sets forth the programmatic elements of a transportation demand management program (the "TDM Program") that shall be implemented by the Applicant to encourage the use of transit (Metrorail, Fairfax Connector, Metrobus, or other public transit service), other high-occupant vehicle commuting modes, walking, biking and teleworking, all in order to reduce automobile trips generated by the multifamily dwelling and the office uses constructed on the Property. The proffered elements of the TDM Program will be implemented through a Transportation Demand Management Work Plan (the "TDM Work Plan") developed by the Applicant with input from and approval by the Town of Herndon Department of Community Development. It is the intent of this Proffer that the TDM Work Plan will be adapted over time to respond to the changing transportation related circumstances of the Property, the surrounding community and the region, as well as to technological and/or other improvements. The Applicant's TDM Work Plan has the objective of meeting the trip reduction goals for signal occupancy vehicles measured at the peak AM/PM hours by 35% for residential uses and 25% for office and commercial uses. The TDM Work Plan shall incorporate any combination of the following elements:
 - i. Contributions to resident and employee Metro fare cards.
 - ii. Contributions to Fairfax Connector, WMATA, or other public transit service approved by the Town.
 - iii. Ride sharing and carpool parking spaces.
 - iv. Bicycle racks and bicycle share stations.
 - v. Bicycle storage rooms and office tenant shower and changing rooms.
 - vi. Tenant incentives to participate in yearly transportation management surveys.
- i. Parking. Parking shall be provided in phases concurrent with development of the

Property and in substantial conformance with the Development Plan and these proffers. Notwithstanding the above, Applicant reserves the right to provide parking at revised ratios as may be permitted at time of site plan by the Town of Herndon Zoning Ordinance or may seek future parking reductions for the Property as permitted by the Town of Herndon Zoning Ordinance, either of which shall not require a Development Plan amendment.

- j. **Micro-Mobility Parking.** The Applicant shall provide space for parking of micro-mobility vehicles, either in a stationed, or un-stationed format in coordination with the Town.

5. GREEN BUILDING.

- a. **Residential Building Certifications.** The Applicant shall design and construct each residential building to achieve either LEED v4 New Construction or Multifamily Midrise certification from U.S. Green Building Council, Multifamily Building certification from National Green Building Standard (NGBS), EarthCraft Multifamily certification, or an equivalent green building program as determined by the Town.
- b. **Office Building Certifications.** The Applicant shall design and construct the office base building to achieve either LEED v4 Core and Shell Development or New Construction Silver certification from U.S. Green Building Council, or an equivalent green building program as determined by the Town.
- c. The Applicant shall include, at the time of application for a building permit for each building, a list of specific credits or design elements incorporated into the building using the then current documentation of the selected green building program for each multifamily building and the office building.
- d. The Applicant shall meet with the Town following application for each site plan to coordinate green building strategies and priority credits, such priorities shall include evaluating green infrastructure for stormwater management and potential bird-friendly design features, and the installation of at least 2 electric vehicle charging stations per garage.
- e. **Low Impact Development.** The Applicant will meet all required local and DEQ stormwater management regulations as required for each phase of the development. This will consist of Low Impact Development (“LID”) facilities onsite to meet the water quality requirements associated with the development. The Applicant shall provide LID measures on the property at the time of project completion for each phase. Such LID facilities may include, but are not limited to: green roof areas, bio retention facilities, tree filters, stormwater filtration systems and/or any other LID

practice proposed by the Applicant, deemed by the Town to be acceptable and permitted by State regulations. The location of these features shall be provided as shown on Development Plan Sheet 12.1, and the type will be decided at the time of Site Plan, in coordination with the Town, for each phase to ensure the most effective and appropriate measures are chosen, and to accommodate limitations and constraints set by the final engineering of the property.

6. CONTRIBUTIONS.

- a. Sanitary Sewer. The Applicant shall make a contribution to the Town in the amount of \$120,000.00 for the construction of a new sewer sanitary line along the Project's Herndon Parkway frontage which shall be paid prior to the issuance of a building permit for the first phase of the project, which could be either the residential phase or the office phase.
- b. Recreation/Community Amenities/Civic Facilities. Prior to the issuance of the last certificate of occupancy for the residential phase, the Applicant shall demonstrate that the value of any proposed recreational on-site amenities/community amenities/civic facilities are equivalent to a minimum of \$1,900.00 per residential unit. The value calculation shall include the cost of amenities such as, but not limited to, benches and seating, outdoor seating and gathering areas, fitness centers, community rooms, swimming pools, decks, artwork, fire pits, trellises, etc. Project building materials are not included in the calculation. The Applicant shall submit the verification of the cost of these improvements to the Town as provided by its general contractor. In the event it is demonstrated that the proposed facilities do not have sufficient value, the Applicant shall provide the remainder in a cash contribution to the Town of Herndon for use on recreational facilities in the Town of Herndon.
- c. Offsite Recreation Contribution. The Applicant shall make a per GFA square foot contribution payment of \$0.35 to the Town for offsite recreation improvements for residential GFA prior to the issuance of the first Certificate of Occupancy for the residential GFA, and \$0.15 for offsite recreation improvements for non-residential GFA prior to the issuance of the Certificate of Occupancy for the office GFA, based on the actual GFA of the building for that phase. Such funds shall be used for the improvements of Town recreational facilities in locations that logically serve the approved development and the HTOC area.
- d. School Contribution.

- i. Per the Residential Development Criteria Implementation Motion adopted by the Fairfax County Board of Supervisors on January 7, 2003, as amended prior to the issuance of the first certificate of occupancy for the residential phase, the Applicant will contribute funds at an assumed rate of 0.062 students per units for elementary school, 0.019 for middle school, 0.031 students per high school multiplied by \$12,262.00 per student generated to the Board of Supervisors for transfer to the Fairfax County School Board to be used for capital improvements and capacity enhancements to schools that serve the Town of Herndon. The contributions will be based on the actual number of residential units constructed, as the total amount may vary. Following approval of this Development Plan and prior to the Applicant's payment of the amount(s) set forth in this Proffer, if Fairfax County should modify the ratio of students per units or the amount of the contribution per student, the Applicant will pay the modified contribution amount for that phase of development to reflect the then current ratio and/or contribution.
 - ii. Prior to beginning construction, the Applicant will notify the Fairfax County Public Schools of the intended construction and anticipated completion date.
 - e. **Fire Department Contribution.** The Applicant shall contribute a total of \$10,000.00 to the Fairfax County Fire and Rescue Department towards the cost of preemptive devices within a two-mile radius of the Property. The contribution shall be paid upon site plan approval for the first building to be constructed on the Property.
7. **DECLARATION OR OWNERS ASSOCIATION.** Prior to any subdivision of the Property, the Applicant shall cause the recordation of one or more declarations creating an owners' association ("OA") and as necessary, condominium owners' associations ("COA") or declarations of covenants and agreements dealing with the governance of maintenance and operation of the Property or other governance documents which will legally bind the Property, (collectively referred to as the "Governance Documents"). Such Governance Documents shall be prepared, be legally effective and recorded prior to the issuance of the first certificate of occupancy. The respective Governance Documents (including budgets provided in any offering or sale materials) shall specify the various proffer and maintenance obligations set forth in the Development plan and these Proffers, including the maintenance of certain streets, bicycle facilities, associated sidewalks and streetscapes, and site amenities such as, but not limited to, the publicly accessible park areas as well as funding, implementation and monitoring of the TDM program, as related to the Property. Purchasers shall be advised in writing of these obligations, and other restrictions, prior to entering into a contract of sale, whether purchasing residential or commercial property. The Governance Documents shall be included in any offering, sale materials or contracts for any condominiums. Purchasers of land or buildings shall be

advised of these obligations in the contract of sale.

8. **MAINTENANCE**. The Applicant shall maintain and replace in-kind all elements within the Development Plan that are shown on Sheet 7.1 as Public Accessible Space and Street Utility Easement Areas. Maintenance commitments include, but are not limited to:
 - a. All plantings including trees, shrubs, perennials, and annuals;
 - b. All associated irrigation elements;
 - c. All hard surfaces;
 - d. All streetscape furnishings including benches, bike racks, trash and recycling receptacles and non-standard structures;
 - e. All lighting fixtures, poles and brackets;
 - f. All sign posts, traffic signal poles, pedestrian signal poles, mast arms, signal heads and control boxes;
 - g. Snow removal;
 - h. Leaf removal;
 - i. Trash, recycling and litter removal;
 - j. Decorative and structural retaining walls;
 - k. Special drainage features, such a Low Impact Design facilities; and
 - l. All urban park amenities including horticultural care, maintenance of all water features, irrigation, lighting, furnishings, paving, and art.
9. **METRORAIL TAX DISTRICT BUYOUT FOR CERTAIN RESIDENTIAL USES**. At least sixty days prior to registration with the Common Interest Community Board of any residential condominium documents that would change the use of all or any portion of the Property to a use that is not subject to the Phase II Dulles Rail Transportation Improvement District (the "Phase II District") tax, the Applicant shall provide a written notice to the Director of the Real Estate Division of the Fairfax County Department of Tax Administration advising that the Applicant intends to register such condominium documents for that portion of the Property. Prior to registering the condominium documents, the Applicant shall pay to Fairfax County a sum equal to the then-present value of Phase II District taxes estimated by the County to be lost as a result of that change in use.
10. **ESCALATION**. All monetary contributions required by these proffers, with the exception of the proffer relating to the public school contribution, shall escalate on a yearly basis

from the base year of 2019 and change effective each January 1 thereafter, based on the Consumer Price Index as published by the Bureau of Labor Statistics, the U.S. Department of Labor for the Washington-Baltimore, MD-VA-DC-WV Consolidated Metropolitan Statistical Area (the “CPI”), as permitted by Virginia State Code Section 15.2-2303.3.3.

11. **SUCCESSORS AND ASSIGNS.** These proffers shall bind and inure to the benefit of the Applicant and his/her successors and assigns
12. **COUNTERPARTS.** These proffers may be executed in one or more counterparts, each of which when so executed and delivered shall be deemed an original document and all of which taken together shall constitute but one and the same instrument.

TITLE OWNER/APPLICANT SIGNATURE TO FOLLOW ON THE NEXT PAGE:

555 Herndon, LLC

Title Owner of 16-4((10))2C

By: 

Name: John E. Kosturiss, Jr.

Title: Authorized Signatory

COMMONWEALTH OF VIRGINIA

CITY/COUNTY OF FAIRFAX, to-wit:

The foregoing instrument was acknowledged before me this 13th day of DECEMBER, 2022
by JOHN KOSTURISS as Notary Public of and on behalf of 555 HERNDON LLC




Kirstyn Barr Jovanovich
Notary Public

Notary Registration No: 7667874

My Commission Expires: 8/31/2025

4811-4117-9274, v. 1

DEVELOPMENT PLAN AMENDMENT / PROFFER CONDITION AMENDMENT

555 HERNDON PARKWAY

TOWN OF HERNDON, VIRGINIA

PROJECT TEAM

THE PROJECT TEAM IS COMPRISED OF THE FOLLOWING:

APPLICANT/OWNER - 555 HERNDON LLC
 ARCHITECTURE: CHRISTOPHER DUNABURG, AIA
 LANDSCAPE ARCHITECT: CHRISTOPHER DUNABURG, AIA
 TRANSPORTATION ENGINEER: CHRISTOPHER DUNABURG, AIA
 ATTORNEY: WIRE GILL, PLLC

FOR ANY QUESTIONS ABOUT THIS DEVELOPMENT PLAN PLEASE CONTACT:


JOHN HESTER III
 FREQUENT MANAGEMENT, INC.
 1000 WISCONSIN AVE., NW, SUITE 1000
 WASHINGTON, DC 20004
 PHONE: 202.291.7400
 EMAIL: jhest@frequent.com

ATTORNEY: WIRE GILL, PLLC

TRANSPORTATION ENGINEER: CHRISTOPHER DUNABURG, AIA
 LANDSCAPE ARCHITECT: CHRISTOPHER DUNABURG, AIA
 ATTORNEY: WIRE GILL, PLLC

FOR ANY QUESTIONS ABOUT THIS DEVELOPMENT PLAN PLEASE CONTACT:

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DATE	REVISION
PENZANCE	
REVISION NO.	REVISION DATE
1.0	08-2007
REVISION NO. 1.0	
REVISION DATE 08-2007	

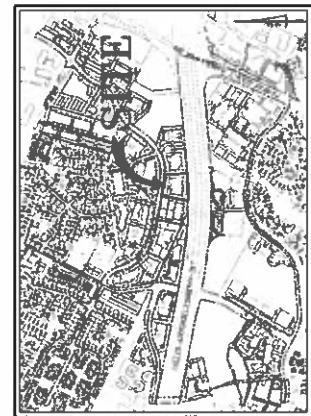dcsl
 GORDON & SLADE
 Architects Engineers
 Christopher Dunaburg, AIA
 WIRE GILL, PLLC



COVER SHEET / INDEX
 SHEET INDEX

555 HERNDON PARKWAY
 DEVELOPMENT PLAN
 COVER SHEET

PROJECT NO. 3322	SCALE 1:2000
DATE 08-2007	AS NOTED
DRAWN BY LA	CHECKED BY LA
SHEET NO.	1.0 o 24.0

SHEET INDEX

Sheet Number	Sheet Title
1.0	COVER SHEET - SHEET INDEX
2.0	REAL PROPS PROPERTY INFORMATION
3.0	EXISTING CONDITIONS - EXISTING TREE SURVEY
4.0	DEVELOPMENT PLAN & TABULATIONS BY BUILDING
4.1	DEVELOPMENT PLAN & TABULATIONS BY BUILDING (ALTERNATE LAYOUT)
5.0	FULL BUILD OUT - PH 2
5.1	DEVELOPMENT PLAN - PH 1
5.2	DEVELOPMENT PLAN - FULL BUILD OUT - PH 2 (ALTERNATE LAYOUT)
5.3	DEVELOPMENT PLAN - PH 1 (ALTERNATE LAYOUT)
5.4	LANDSCAPE PLAN
5.5	HARDSCAPE PLAN
7.0	PUBLIC ACCESSIBLE OPEN SPACE
8.0	PUBLIC ACCESSTION, EASEMENTS, ACCESSIBLE SPACE
8.1	PRIVATE OPEN SPACE PLAN
9.0	PRIVATE OPEN SPACE PLAN (ALTERNATE LAYOUT)
9.1	PROPOSED GRAVITY PLAN & LIMITS
10.0	SUM DRAINAGE PLAN
10.1	FIRE ACCESS PLAN
10.2	FIRE ACCESS PLAN (INTERIM CONDITION)
11.0	TRUCK TURNING MOVEMENTS
11.1	TRUCK TURNING MOVEMENTS
11.2	TRUCK TURNING MOVEMENTS (ALTERNATE LAYOUT)
12.0	PROPOSED GRAVITY PLAN & LIMITS
12.1	SUM DRAINAGE PLAN
12.2	APP. COMPUTATIONS
13.0	ILLUSTRATIVE PLAN
14.0	ILLUSTRATIVE PARKING PLAN (ALTERNATE LAYOUT)
14.1	SHADY ANALYSIS (ALTERNATE LAYOUT)
15.0	PERSPECTIVE VIEWS
15.1	ARCHITECTURAL ELEVATIONS
16.0	INTERIM ARCHITECTURAL ELEVATIONS (PHASE-1)
16.1	STREET LEVEL CROSS-SECTIONS
16.2	BUILDING CROSS-SECTIONS
16.3	BUILDING CROSS-SECTIONS
17.0	BUILDING CROSS-SECTIONS
17.1	BUILDING CROSS-SECTIONS
17.2	BUILDING CROSS-SECTIONS
17.3	BUILDING CROSS-SECTIONS (ALTERNATE LAYOUT)
17.4	BUILDING CROSS-SECTIONS (ALTERNATE LAYOUT)
17.5	BUILDING CROSS-SECTIONS (ALTERNATE LAYOUT)
18.0	STREET LEVEL CROSS-SECTIONS
18.1	STREET LEVEL CROSS-SECTIONS
18.2	PRELIMINARY SIGNAL EXHIBIT (IF WARRANTED)
18.3	ULTIMATE SIGNAL EXHIBIT (IF WARRANTED)
18.4	PROPOSED ULTIMATE CONDITIONS OF LOOP ROAD
18.5	STREETSCAPE ZONING MODIFICATION
19.0	ILLUSTRATIVE DESIGN AMENITIES
19.1	HERNDON IDENTITY
20.0	ILLUSTRATIVE LANDSCAPE - STREETSCAPE
21.0	ILLUSTRATIVE LANDSCAPE - PLAZA
22.0	ON-PUBLIC PRIVATE AMENITIES
23.0	SUSTAINABLE PRACTICES
24.0	SIGHT DISTANCE PLAN & PROFILES

PROJECT NARRATIVE		GENERAL NOTES & PROPERTY INFORMATION	
1. GENERAL NOTES.	2. THE SUBJECT PROPERTY SHOWN HERON IS RECORDED IN THE LAND RECORDS OF FAIRFAX COUNTY, VIRGINIA AS FOLLOWS.	3. PER THE TOWN OF HERNDON ZONING ORDINANCE, THE PARCEL IS CURRENTLY ZONED PD-TOC (PLANNED DEVELOPMENT-TRANSIT ORIENTED CORE).	4. THE SUBJECT PROPERTY IS BOUND ON THE NORTH AND ON THE EAST BY OFFICE USE, ON THE WEST BY OFFICE USE, AND ON THE SOUTH BY THE CUL-DE-SOUL ROAD, THE LAND TO THE WEST, AND TO THE EAST IS ZONED PD-TOC. THE LAND TO THE NORTH OF THE SITE IS ZONED OFFICE & LIGHT INDUSTRIAL, AND THE LAND TO THE SOUTH IS ZONED INDUSTRIAL.
5. THE SUBJECT PROPERTY IS FULLY DEVELOPED AND CONTAINS ONE (1) TWO-STORY OFFICE BUILDINGS WITH A PARKING LOT. THERE IS VEGETATION LOCATED ALONG THE PERIMETER OF THE PROPERTY.	6. THE SUBJECT PROPERTY WILL REMAIN ZONED PD-TOC, SUBJECT TO THE PD-TOC REQUIREMENTS OF SECTION 745.6 OF THE TOWN OF HERNDON MUNICIPAL CODE.	7. BOUNDARY SURVEY (ALTA/NSHA) TITLE SURVEY WAS COMPLETED FOR THE SUBJECT PROPERTY BY BOWMAN CONSULTING DATA REVISED JANUARY 16, 2015.	8. TOPOGRAPHY AND PHYSICAL IMPROVEMENTS SHOWN HERON ARE BASED ON A CURRENT FIELD SURVEY COMPLETED BY CHAVIS TO HER CONSULTANTS LTD. BETWEEN THE DATES OF AUGUST 12TH AND AUGUST 15, 2015. THE CONTOUR INTERVAL IS ONE (1) FOOT.
9. DURING THE PROCESS OF OUR PHYSICAL SURVEY, NO EVIDENCE OF A CEMETERY WAS FOUND. NO FURTHER INSPECTION OF THIS PROPERTY HAS BEEN MADE FOR POSSIBLE CEMETERIES.	10. THE PROPERTY SHOWN HERON IS LOCATED ON THE FLOOD INSURANCE RATE MAP (FIRM). COMMUNITY PANEL NO. 51820210 E, REVISED ON SEPTEMBER 17, 2010. BY GRAPHICAL DEPICTION ONLY, THE PROPERTY SHOWN HERON IS SHOWN IN FLOOD ZONE "X". AREAS DETERMINED TO BE OUTSIDE THE 0.2% ANNUAL CHANCE FLOODPLAIN.	11. THE SUBJECT PROPERTY LIES COMPLETELY OUTSIDE OF THE CHESAPEAKE BAY RESOURCE PROTECTION AREA (RPA) AS PER THE 2006 TOWN OF HERNDON CHESAPEAKE BAY PRESERVATION AREAS MAP.	12. A WETLAND DELINEATION WAS NOT DONE SINCE THE SITE IS FULLY DEVELOPED.
13. TO THE BEST OF OUR KNOWLEDGE, THERE ARE NO KNOWN HAZARDOUS OR TOXIC SUBSTANCES LOCATED ON THE SUBJECT PROPERTY.	14. TO THE BEST OF OUR KNOWLEDGE, THERE ARE NO KNOWN SCENIC ASSETS OR NATURAL FEATURES LOCATED ON THE SUBJECT PROPERTY THAT ARE DESERVING OF PROTECTION AND PRESERVATION.	15. THE SUBJECT PROPERTY LIES COMPLETELY WITHIN THE JURISDICTION OF THE TOWN OF HERNDON AND IS CURRENTLY LOCATED WITHIN THE DRANESVILLE TOWN OF HERNDON TRAILS DULLES RAIL WEST DISTRICT.	16. THE SUBJECT PROPERTY IS TO BE SERVED BY PUBLIC WATER AND SANITARY SEWER. ALL PROPOSED SANITARY SEWER AND WATER SERVICES WILL BE DESIGNED IN ACCORDANCE WITH APPLICABLE TOWN OF HERNDON REQUIREMENTS.
17. THE STORMWATER MANAGEMENT AND BEST MANAGEMENT PRACTICE FACILITY LOCATIONS AND DIMENSIONS ARE CONCEPTUAL IN NATURE AND MAY VARY IN LOCATION AND SIZE WITH FINAL ENGINEERING. STORMWATER MANAGEMENT SHALL BE PROVIDED IN ACCORDANCE WITH TOWN OF HERNDON REQUIREMENTS.	18. NOTWITHSTANDING THE IMPROVEMENTS AND TABULATIONS SHOWN ON THIS PLAN, THE APPLICANT RESERVES THE RIGHT TO MAKE MODIFICATIONS TO THE FINAL DESIGN PLAN AND TO COMPLY WITH FINAL ENGINEERING AND NEW CRITERIA AND REGULATIONS WHICH MAY BE ADOPTED BY THE TOWN OF HERNDON SUBSEQUENT TO THE SUBMISSION OF THIS APPLICATION. PROVIDED THAT SUCH MODIFICATIONS ARE CONSISTENT WITH THE APPROVED DEVELOPMENT PLAN, THE BUILDING FOOTPRINTS AND SITE IMPROVEMENTS SHOWN HEREIN ARE PRELIMINARY. FINAL BUILDING FOOTPRINTS AND SITE IMPROVEMENTS WILL BE CONFIGURED AT THE TIME OF SITE PLAN APPROVAL, SUBJECT TO MARKET CONDITIONS, BUT SHALL BE IN SUBSTANTIAL CONFORMANCE WITH THE APPROVED DEVELOPMENT PLAN.	<p style="text-align: center;">365 HERNDON PARKWAY DEVELOPMENT PLAN</p> <p style="text-align: center;">TOWN OF HERNDON, VIRGINIA</p> <p style="text-align: right;">PROJECT NO. 17-46-2022 DATE: 11-16-2017 SCALES: AS BUILT DRAWN: J.A.44 CHECKED: J.A.44 APPROVED: J.A.44 SHEET NO. 20-24.0</p>	
<p style="text-align: center;">LEGAL DESCRIPTION:</p> <p>TAX MAP 1-4 (110) 2C 555 HERNDON PARKWAY HERNDON, VIRGINIA 20170</p> <p>ALL OF THAT CERTAIN LOT, PIECE OR PARCEL OF LAND, SITUATE, LYING AND BEING IN THE TOWN OF HERNDON, FAIRFAX COUNTY, VIRGINIA, AND MORE PARTICULARLY DESCRIBED AS FOLLOWS</p> <p>PARCEL 2C PARKWAY TRADE CENTER, CONTAINING AN AREA OF 189.218 SQUARE FEET OR 4.349 ACRES OF LAND MORE OR LESS, AS SHOWN ON A PLAT ATTACHED TO A DEED OF RESUBDIVISION AND EASEMENT RECORDED AUGUST 17, 1983 AS DEED BOOK 5338 PAGE 1680 AMONG THE LAND RECORDS OF FAIRFAX COUNTY, VIRGINIA.</p> <p>TOGETHER WITH AND SUBJECT TO THOSE EASEMENTS CONVEYED AT DEED BOOK 5038 PAGE 1680 AS APPROPRIATE.</p>			
<p style="text-align: center;">METRO PROXIMITY MAP SCALE: 1" = 1,000'</p>			
<p style="text-align: center;">SOILS MAP SCALE: 1" = 200'</p>			

NOTES

EXISTING DRAINAGE SYSTEMS & RELATED TO THE HERNDON
PROJECT SYSTEM (EST. 1961 - NORTH AS ESTABLISHED FROM A CEMENT
PIPE SURVEY. DATA SHOWN BELOW IS REFERENCED TO THE NATIONAL
SURVEY. DATA WHICH IS NOT REFERENCED TO THE NATIONAL
SURVEY, WHERE NECESSARY, IS TO BE CONFIRMED WITH
PROPERTY OWNERS OR OTHER MEANS.

STORM STRUCTURE DATA

1. 250.0 LF OF 15" RCP


Rain D. = 367.44
Rev D. = 367.44
Rev W. = (From 5168 - 367.42)


PENZANCE				REVISION	
christopher GROVE / SHADE SPEECH & ASSOCIATES INC.		WIRE GILL		PROJECT NO. 6000-00000000	
dcs		CITY OF HERNDON LIC. NO. 2025 EXPIRED 07-2022		TOWN OF HERNDON, VIRGINIA	
BUILDING TABULATIONS		DEVELOPMENT PLAN		355 HERNDON PARKWAY	
DEVELOPMENT TABULATIONS		DEVELOPMENT PLAN		PROJECT NO. 6000-00000000	
Total Site Area	189,218			SCALE	N.T.S.
Maximum FAR	3.69			DATE	6-06-2022
Maximum GFA	698,182			CHECK	DC-3 DRAWN CHECKED SWEEPT
Phase	Use	Approximate SF in Development Plan	Minimum Required in Development Plan	Minimum Required Parking	Maximum Height (ft): Heights (floors) ¹
			CARS	CARS BIKEs	Up to 10' Up to 110'
Building A	Retail	403,000 5,000	414 NA	0.75/UNIT 1.25/1000 SF	414 7 2
Building B	Office	200,000	NA	2.0/1000 SF 0.2/1,000 SF	40 Up to 24' Up to 275' NA
				Minimum Height - All Buildings	Maximum SF Minimum SF Maximum SF
				Minimum Height - All Buildings	340,000 5,000 498,182
				Maximum Height - All Buildings	5,000 10,000
<p>NOTES:</p> <ol style="list-style-type: none"> Building heights are above average site elevation and include above-grade parking levels, but do not include mechanical penthouse requirements or rooftop facilities (pool, deck, club room, etc). Square footage and dwelling units are approximate. Applicant reserves the right to adjust GFA, unit counts and heights for each building in accordance with the approved development plans and profers Additional retail may be provided above the square footage shown provided that the overall final square footage will not exceed 698,182 GFA. 					

PENZANCE																																	
DATE	REVISION																																
2022-07-12	0																																
ORCHARD / SLADE		DESIGN																															
WIRE GATE		LAWRENCE & CO., INC.																															
ALTERNATE LAYOUT		TABULATIONS BY DEVELOPMENT PLAN																															
(ALTERNATE LAYOUT)		TOWN OF HENDON, VIRGINIA																															
355 HENDON PARKWAY		DEVELOPMENT PLAN																															
PROJECT NO. 2022-07-01		SCALE: N.T.S.																															
DATE: 07-12-2022		DIMENSIONS: D.C.-S.																															
SHEET NO.: 4.1		DRAWN BY: J.A.																															
Attachment 332		CHECKED BY:																															
22-O-28																																	
<p>BUILDING B</p> <p>BUILDING A</p> <p>BUILDING B</p> <p>BUILDING A</p> <p>BUILDING A</p> <p>BUILDING B</p> <p>Development Plan</p> <p>Minimum Height - All Buildings</p> <p>Maximum Height - All Buildings</p>																																	
<p>DEVELOPMENT TABULATIONS</p> <table border="1"> <thead> <tr> <th>Total Site Area</th> <th>189,218</th> <th>Approximate SF in Development Plan</th> <th>Approximate Units in Development Plan</th> <th>Minimum Required Parking Spaces in Development Plan</th> <th>Minimum Required Parking Cars</th> <th>Maximum Height (ft.)¹</th> <th>Maximum Height (floors)²</th> <th>Minimum Heights (floors)³</th> <th>Maximum SF</th> </tr> </thead> <tbody> <tr> <td>Maximum FAR</td> <td>3.657</td> <td></td> <td></td> <td></td> <td></td> <td></td> <td></td> <td></td> <td></td> </tr> <tr> <td>Maximum GFA</td> <td>692,000</td> <td></td> <td></td> <td></td> <td></td> <td></td> <td></td> <td></td> <td></td> </tr> </tbody> </table> <p>Phase</p> <p>Use</p> <p>Approximate SF in Development Plan</p> <p>Approximate Units in Development Plan</p> <p>Minimum Required Parking Spaces in Development Plan</p> <p>Parking Ratios¹</p> <p>CARS</p> <p>BIKES</p> <p>CARS</p> <p>BIKES</p> <p>Maximum Height (ft.)¹</p> <p>Maximum Height (floors)²</p> <p>Minimum Heights (floors)³</p> <p>Maximum SF</p>				Total Site Area	189,218	Approximate SF in Development Plan	Approximate Units in Development Plan	Minimum Required Parking Spaces in Development Plan	Minimum Required Parking Cars	Maximum Height (ft.) ¹	Maximum Height (floors) ²	Minimum Heights (floors) ³	Maximum SF	Maximum FAR	3.657									Maximum GFA	692,000								
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Maximum FAR	3.657																																
Maximum GFA	692,000																																
Building A	Residential Retail	404,000 5,000	400 NA	1.0/Unit 0.75/UNIT 1.25/1000 SF 0.25/1,000 SF	400 300 7 2	Up to 10' Up to 11'	6	338,000 5,000	482,000 10,000																								
Building B	Office	200,000	NA	2.0/1000 SF 0.2/1,000 SF	400 40	Up to 24' Up to 275'	NA	200,000	200,000																								


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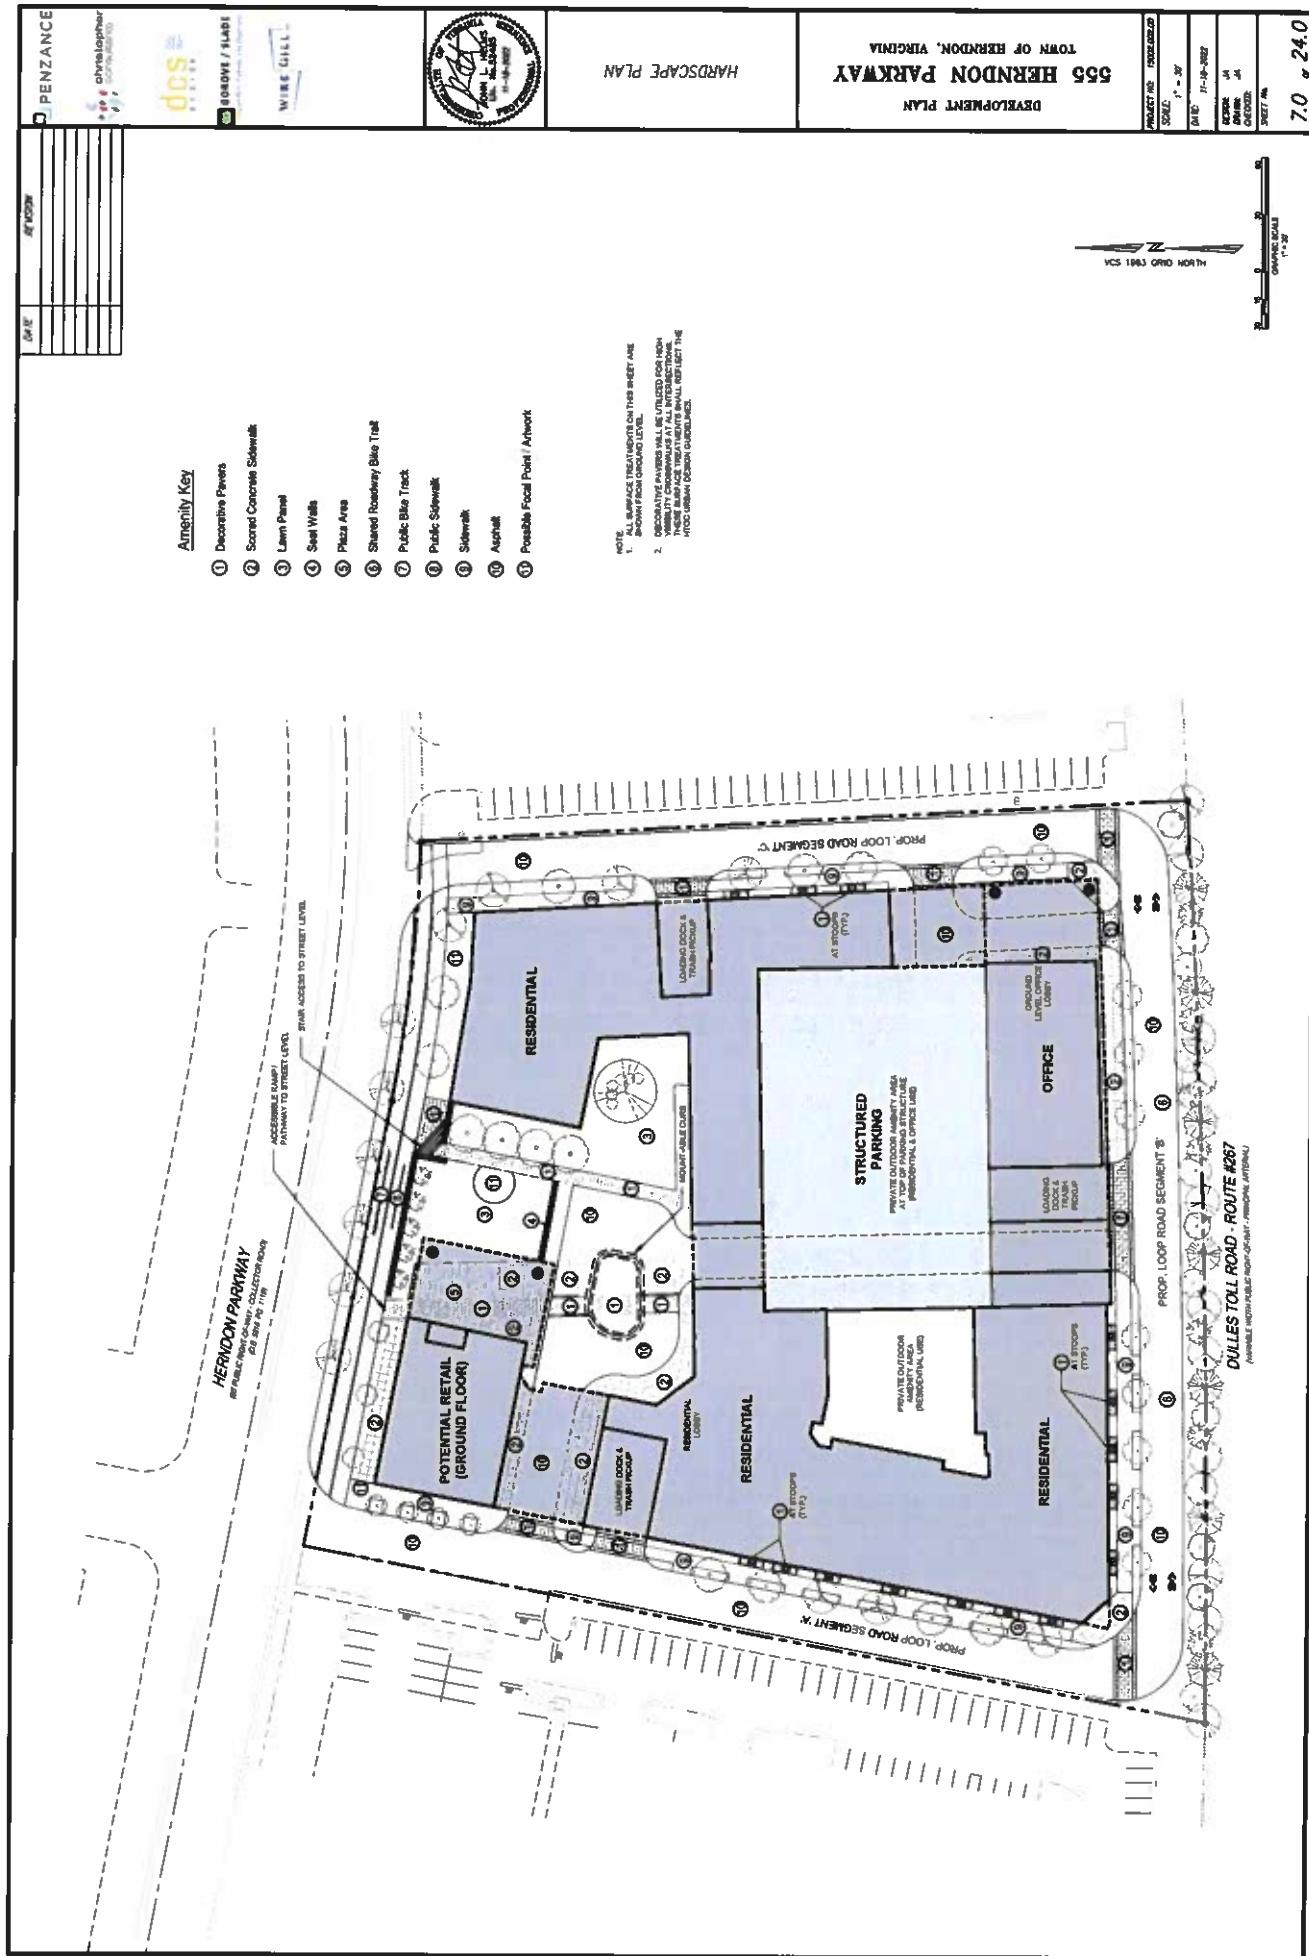
1. Building heights are above average site elevation and include above-grade parking levels, but do not include mechanical penthouse requirements or rooftop facilities (pool, deck, club room, etc.).
2. Square footage and dwelling units are approximate.
3. Applicant reserves the right to adjust GFA, unit counts and heights for each building in accordance with the approved development plans and profilers.
4. Additional retail may be provided above the square footage shown provided that the overall final square footage will not exceed 692,000 GFA.



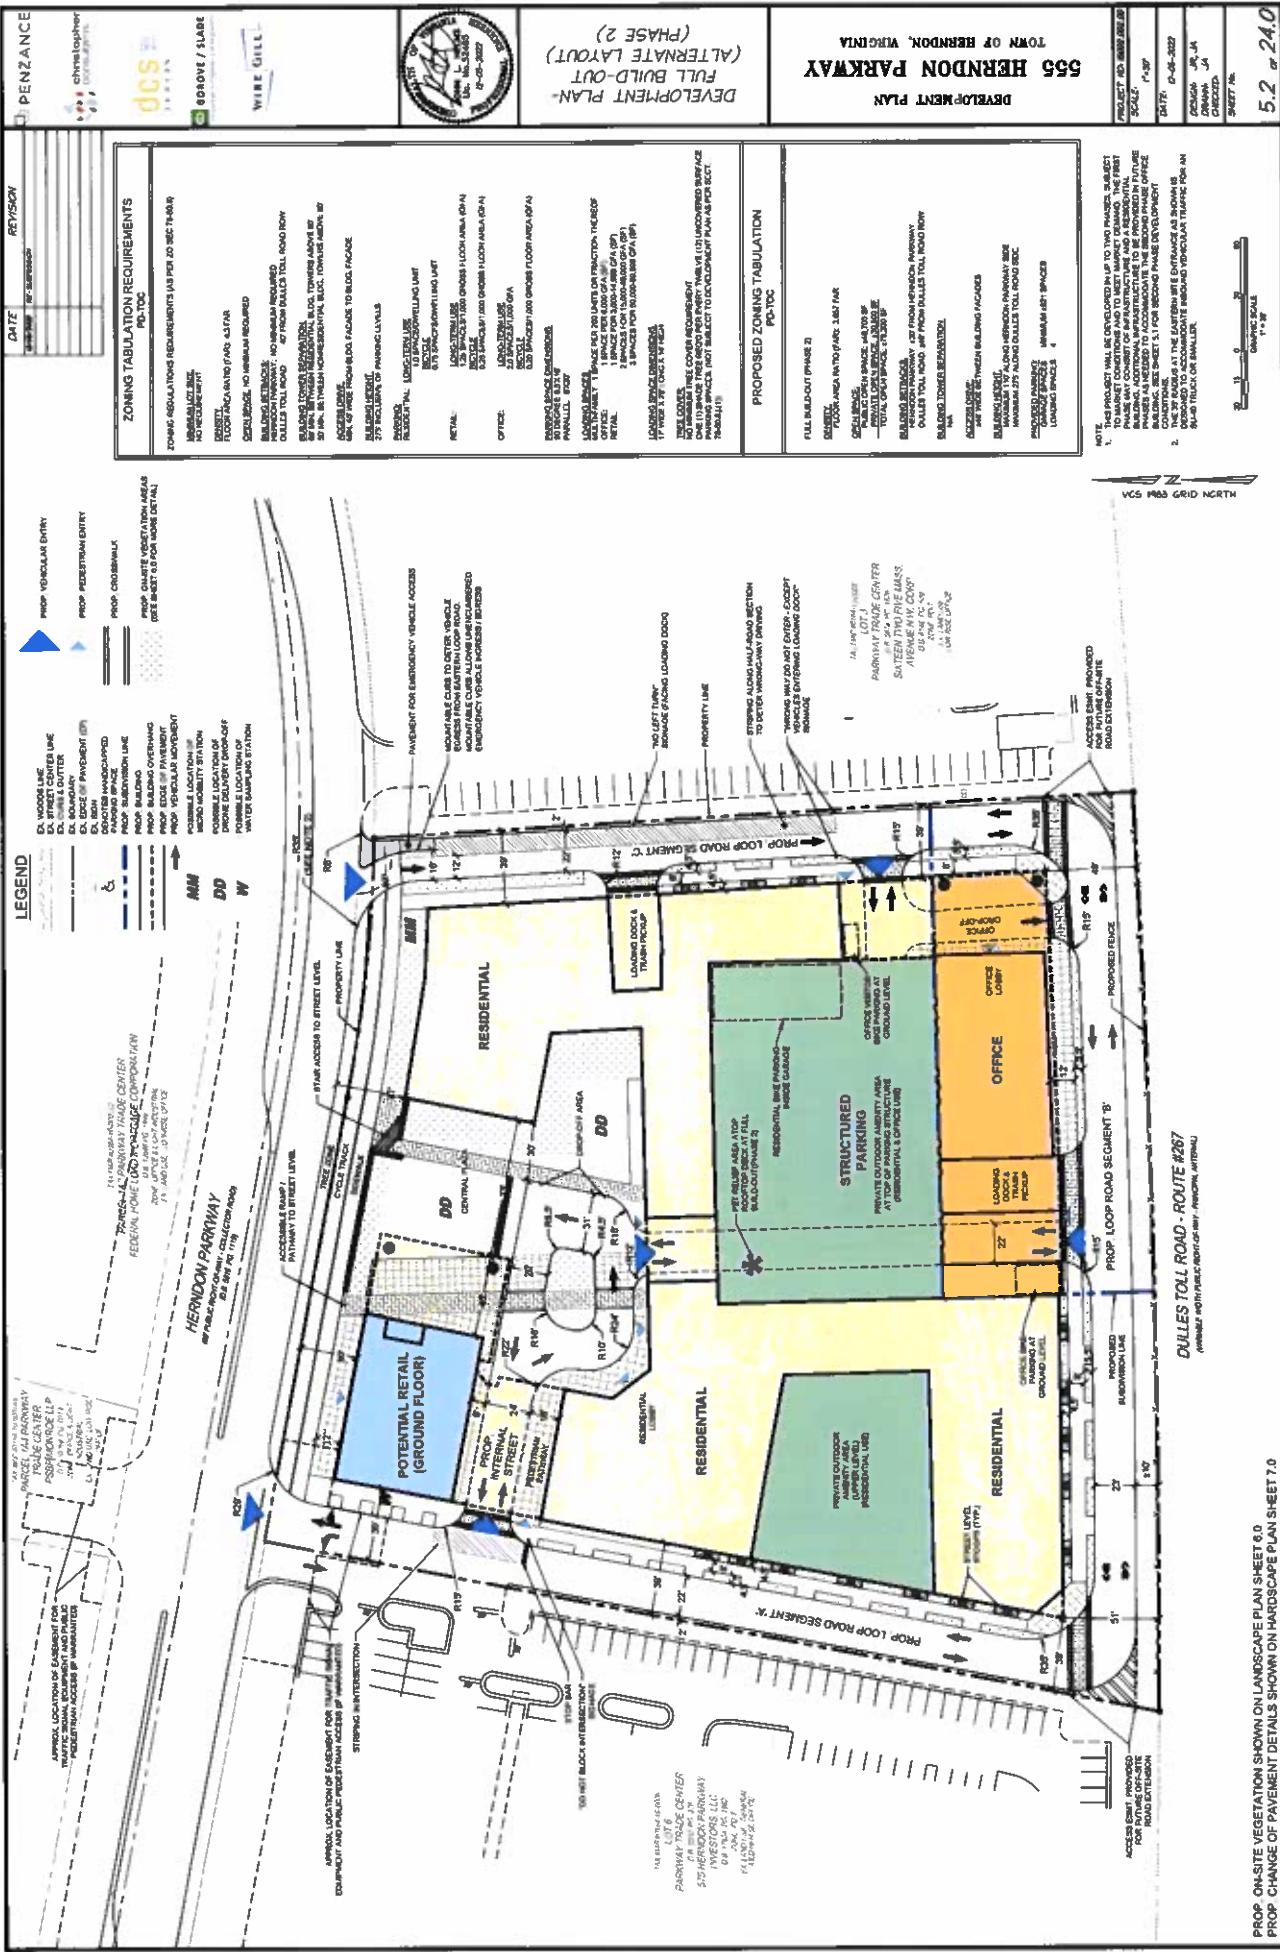

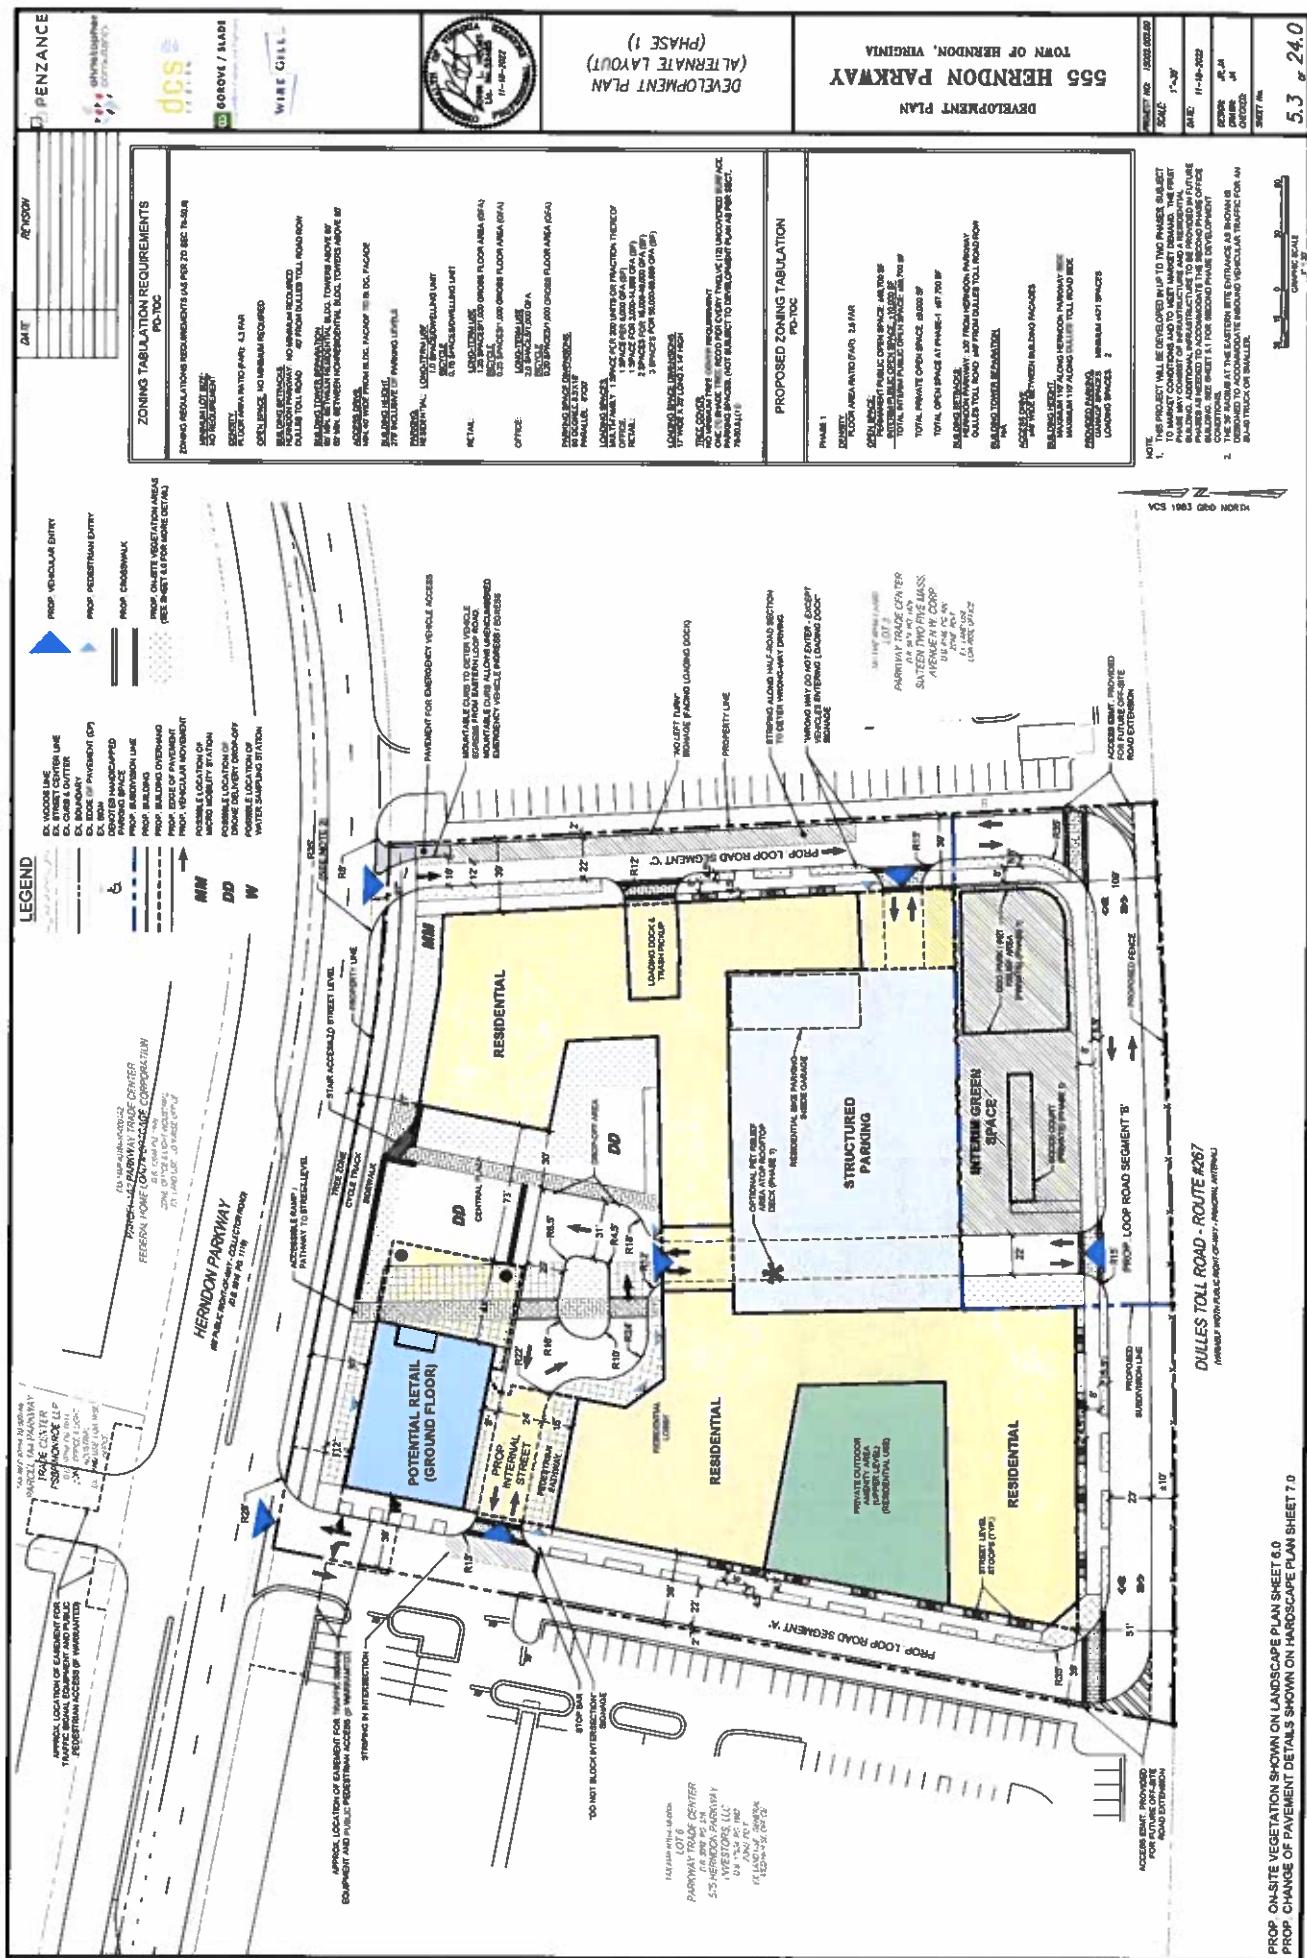PROP. ON-SITE VEGETATION & GROWN ON LANDSCAPE PLAN SHEET 6.0
PROP. CHANGE OF PAVEMENT DETAILS SHOWN ON HARDSCAPE PLAN SHEET 7.0



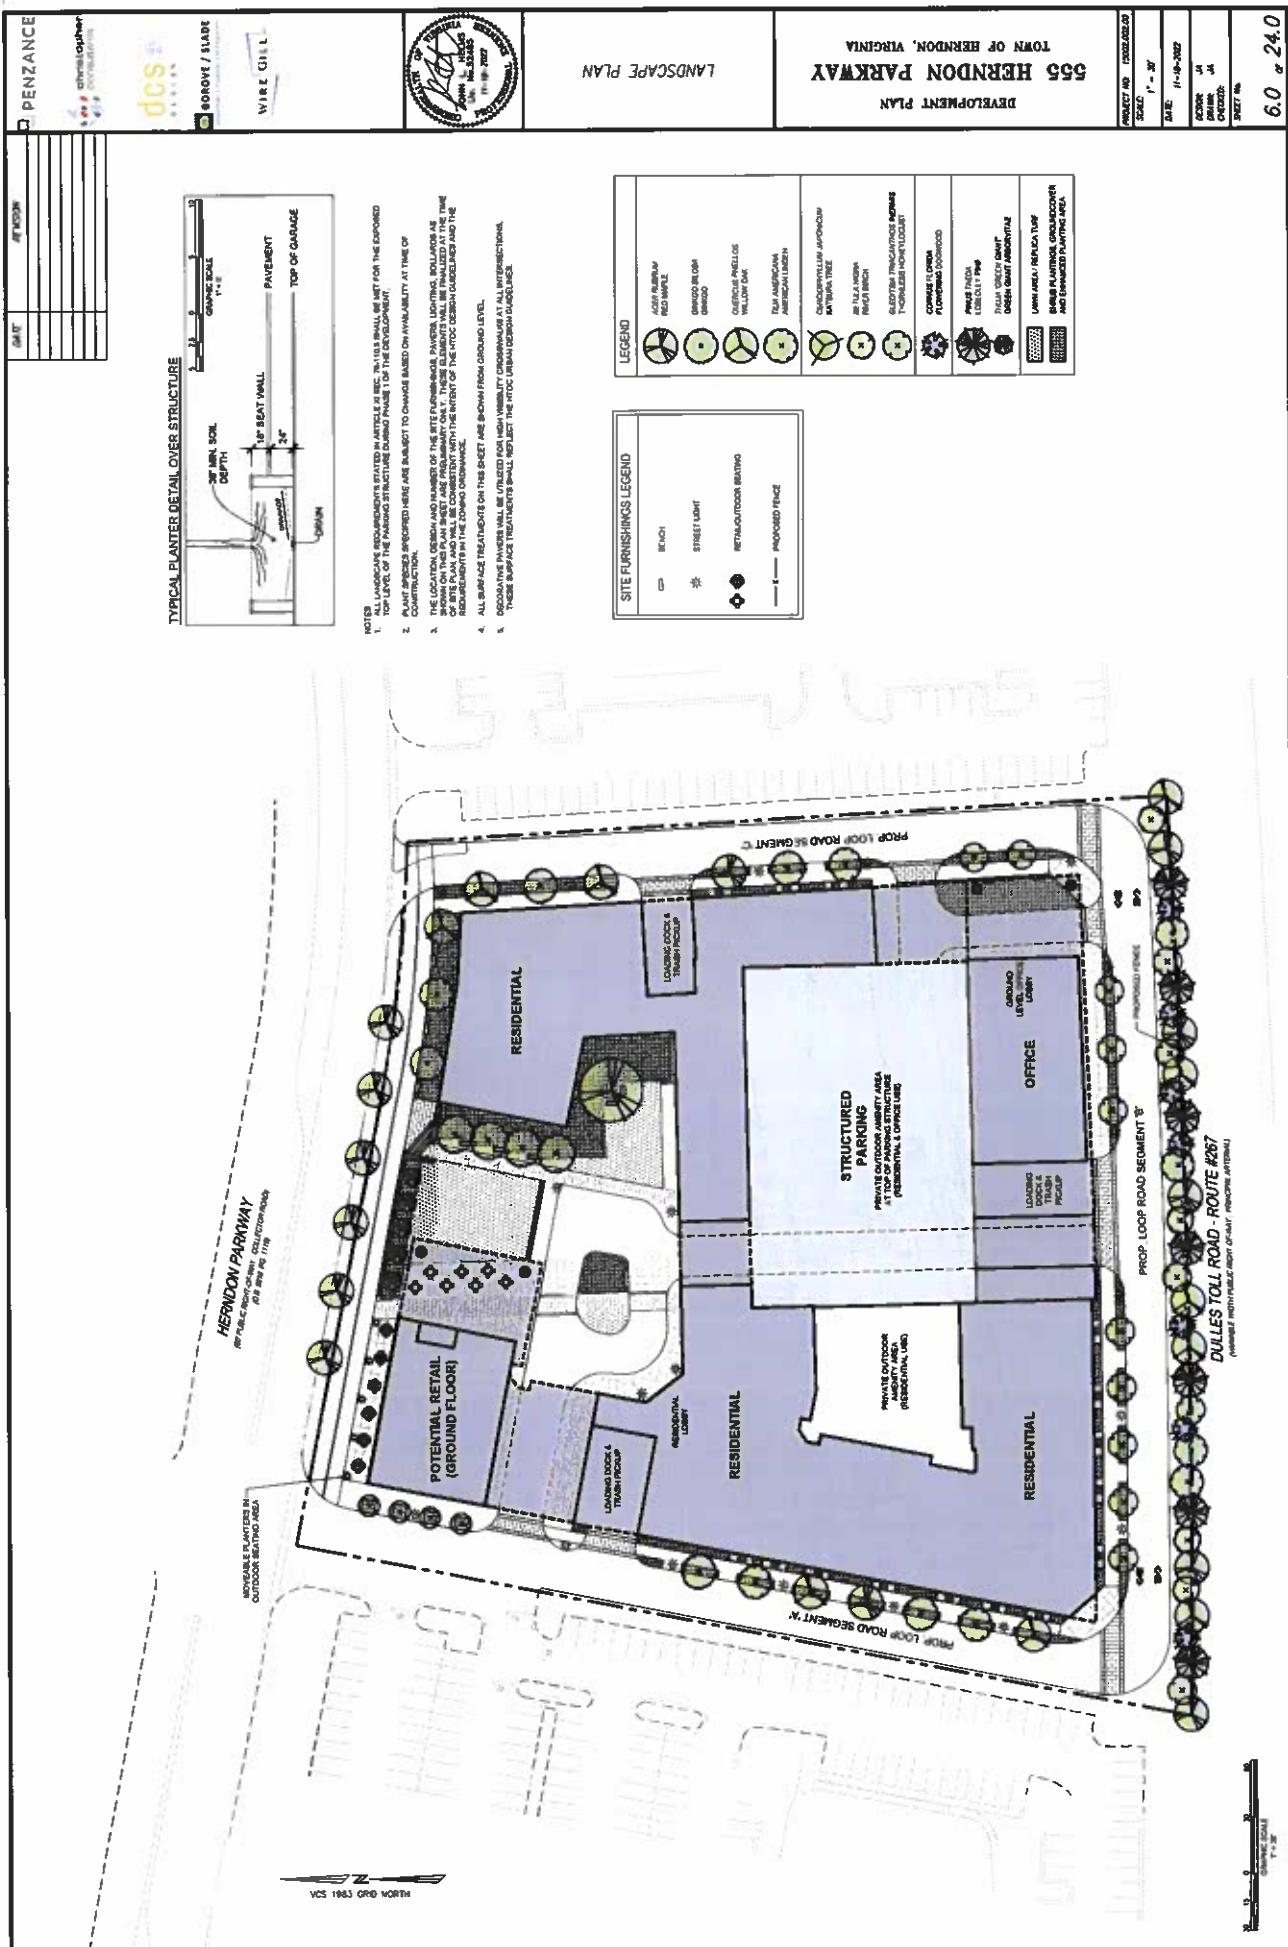

OPEN SPACE PLAN

555 HENDON PARKWAY
TOWN OF HERNDON, VIRGINIA

DEVELOPMENT PLAN

PUBLIC-ACCESSIBLE OPEN SPACE

PROPERTY NO. 15202-002-00
SCALE: 1" = 30'
Date: 11-16-2022
Section: 44
Block: 44
SHEET No.: 8
8.0 x 24.0

OPEN SPACE PLAN

TOTAL SITE AREA: 4.34 AC

OPEN SPACE AREA REQUIREMENT:
0.00 AC (0% OF SITE)

OPEN SPACE PROVIDED AT GRADE:
± 1.12 AC (± 26% OF SITE)

**NOTE: PRIOR APPROVAL DPL-1-01 PROVIDED 1.15 AC
(OF A1-GRADE OPEN SPACE)**

HENDON PARKWAY
Private Residential Community

POTENTIAL RETAIL (GROUND FLOOR)

RESIDENTIAL

STRUCTURED PARKING
*PRIVATE OUTDOOR AMENITY AREA
A PRIVATE OUTDOOR AMENITY AREA FOR
RESIDENTIAL, OFFICE USE*

OFFICE

PRIVATE OUTDOOR AMENITY AREA
RESIDENTIAL USE

RESIDENTIAL

LOADING DOCK & TRASH PICKUP

LOADING DOCK & TRASH PICKUP

LOADING DOCK & TRASH PICKUP

PROP. LOOP ROAD SEGMENT C

PROP. LOOP ROAD SEGMENT B

DULLES TOLL ROAD ROUTE #267
PARALLEL TO THE ABOVE OWNER PRIVATE AREA

Attachment 7332
22-O-28

555 HERNDON PARKWAY
TOWN OF HERNDON, VIRGINIA
DEVELOPMENT PLAN

PRIVATE OPEN SPACE PLAN

PRIVATE OPEN SPACE PROVIDED ON PODIUM LEVEL: ±30,500 S.F.

OPEN SPACE TABULATIONS


TOTAL SITE AREA: 186,150 SF; PUBLIC OPEN SPACE = 48,700 SF	
PRIVATE OPEN SPACE (SQ. FT.)	PRIVATE OPEN SPACE (% OF SITE AREA)
RESIDENTIAL & OFFICE	21,500 SQ. FT. 11.4%
RESIDENTIAL	9,000 SQ. FT. 4.7%
TOTAL OPEN SPACE (% OF SITE) = 54.0%.	

HERNDON PARKWAY
Proposed Right-of-Way
All sites per Construction Drawings


DULLES TOLL ROAD / ROUTE #267
(Interstate 66 Public Right-of-Way - Principal Arterial)


PROJECT NO. 8002-2020-00
SCALE: 1" = 30'
DATE: 8-10-2020
DESIGNER: J.A. DURRAN C.C.C.
SHEET NO. 9/1

३

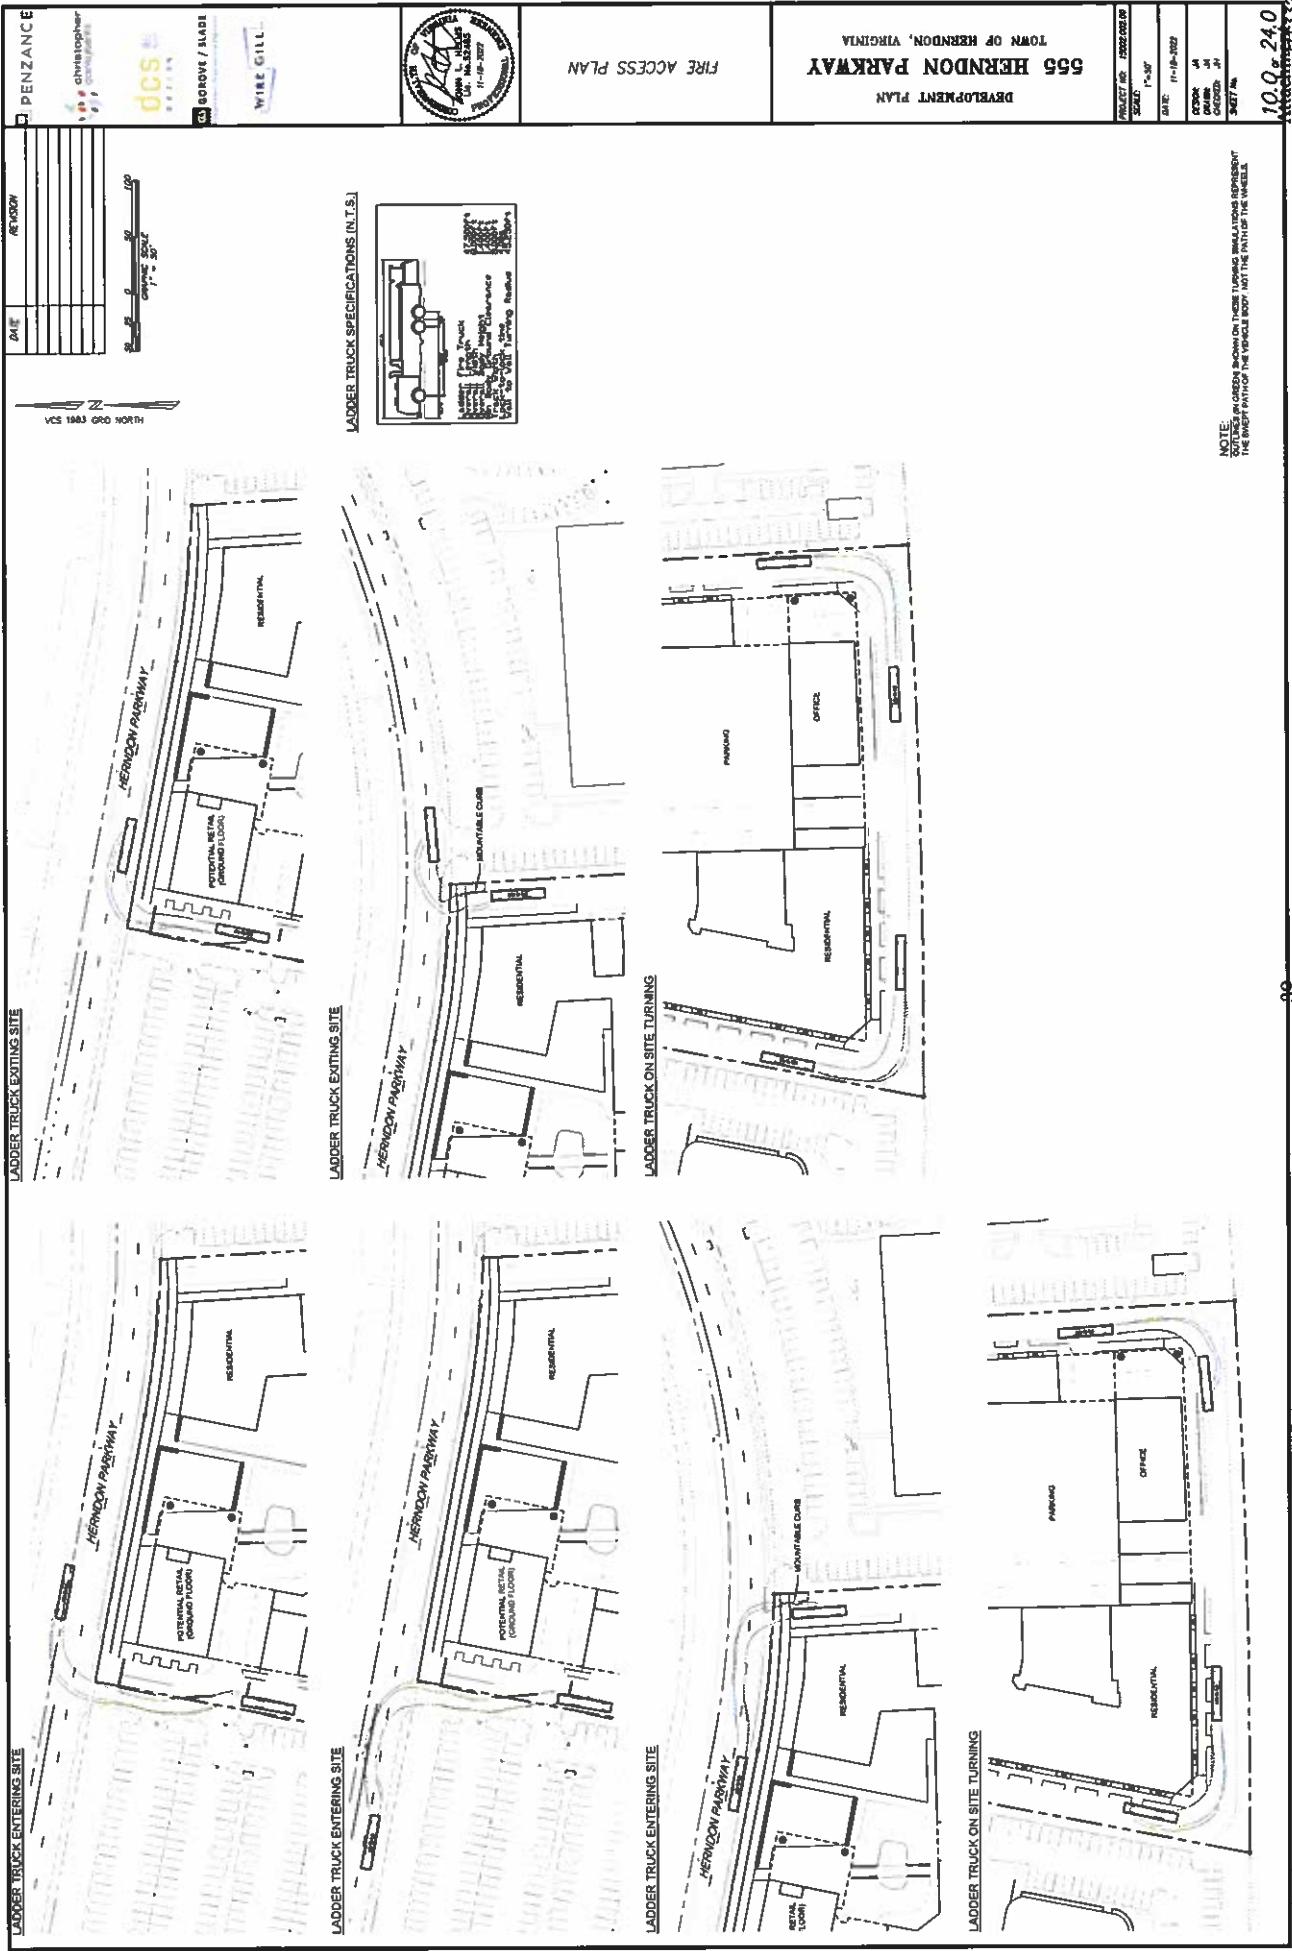

LADDER TRUCK ENTERING COURTYARD		LADDER TRUCK EXITING COURTYARD		FIRE ACCESS PLAN		TOWN OF HERNDON, VIRGINIA 565 HERNDON PARKWAY DEVELOPMENT PLAN		PLAT	
<p>DCS</p> <p>CHIEF COUNSELOR WIRE CUTTER GROVE / BLADE</p> <p>VCS 1983 GRID NORTH</p> <p>DATE: 11-16-2022</p>		<p>DATE: 11-16-2022</p>		<p>LADDER TRUCK SPECIFICATIONS (N.T.S.)</p>		<p>NOTE: OUTER EDGES SHOWN ON THESE TURNING RADII ARE NOT THE PATH OF THE VEHICLE BODY, NOT THE WHEELS.</p>		<p>AERIAL FIRE ACCESS PFM COMPLIANCE EXHIBIT</p> <p>LEGEND</p> <ul style="list-style-type: none"> MEETS PFM REQUIREMENTS FOR AERIAL FIRE APPARATUS ACCESS (19'-30' FROM FIRE ACCESS LANE) NEAR TO MEETING PFM REQUIREMENTS FOR AERIAL FIRE APPARATUS ACCESS (30'-40' FROM FIRE ACCESS LANE) DOES NOT MEET PFM REQUIREMENTS FOR AERIAL FIRE APPARATUS ACCESS (GREATER THAN 40' FROM FIRE ACCESS LANE) 	
<p>PARKING GARAGE AERIAL FIRE ACCESS WAIVER REQUEST</p> <p>September 1, 2022</p> <p>Office of the Herndon Fire Marshal 1305 Government Center Avenue Herndon, VA 20171 515 Herndon Parkway, Herndon, Va. 20170 DP #215 Carla Rutherford Fairfax County Public Safety Office Manager Election #2013-2611</p> <p>This is a request for a waiver under the Fairfax County Public Safety Office Manual (PSOM) Section 8.202.2.</p> <p>Section 8.202.2 states that "Vehicles including, but not limited to, fire trucks, trucks or other vehicles used for fire fighting, travel the apparatus entry route for apparatus." In this case, the parking garage does not represent an apparatus entry route for apparatus.</p> <p>The developer has consulted with the Herndon Fire Department and has determined that the proposed parking garage is a temporary use of land by a residential land owner. Since the developer does not propose a permanent fixture on the land, the developer may offer to provide the required protective measures in a short-term effort.</p> <p>With 23 complimentary residents, the vehicle coverage for this garage is being utilized. Additionally, over 20 buildings offer the same coverage in this neighborhood, with no individual buildings having more than 10% usage of their total capacity due to the nature of open structures, such as office buildings, retail space, and residential units.</p> <p>The City of Herndon, Virginia would be compensated for the additional construction and office building's fire alarm system and would receive notification upon activation of the garage's sprinkler system.</p> <p>We appreciate your understanding and support in this matter. This waiver is effective upon approval by the Fairfax County Fire Protection Authority, and the City of Herndon Fire Department.</p>		<p>DATE: 11-16-2022</p> <p>SCALE: 1"-00'</p> <p>SECTION: A-A</p> <p>VIEW: 14'</p> <p>CHARTER: 4"</p> <p>SHEET NO. 22</p>		<p>DATE: 11-16-2022</p> <p>SCALE: 1"-00'</p> <p>SECTION: B-B</p> <p>VIEW: 14'</p> <p>CHARTER: 4"</p> <p>SHEET NO. 24</p>					

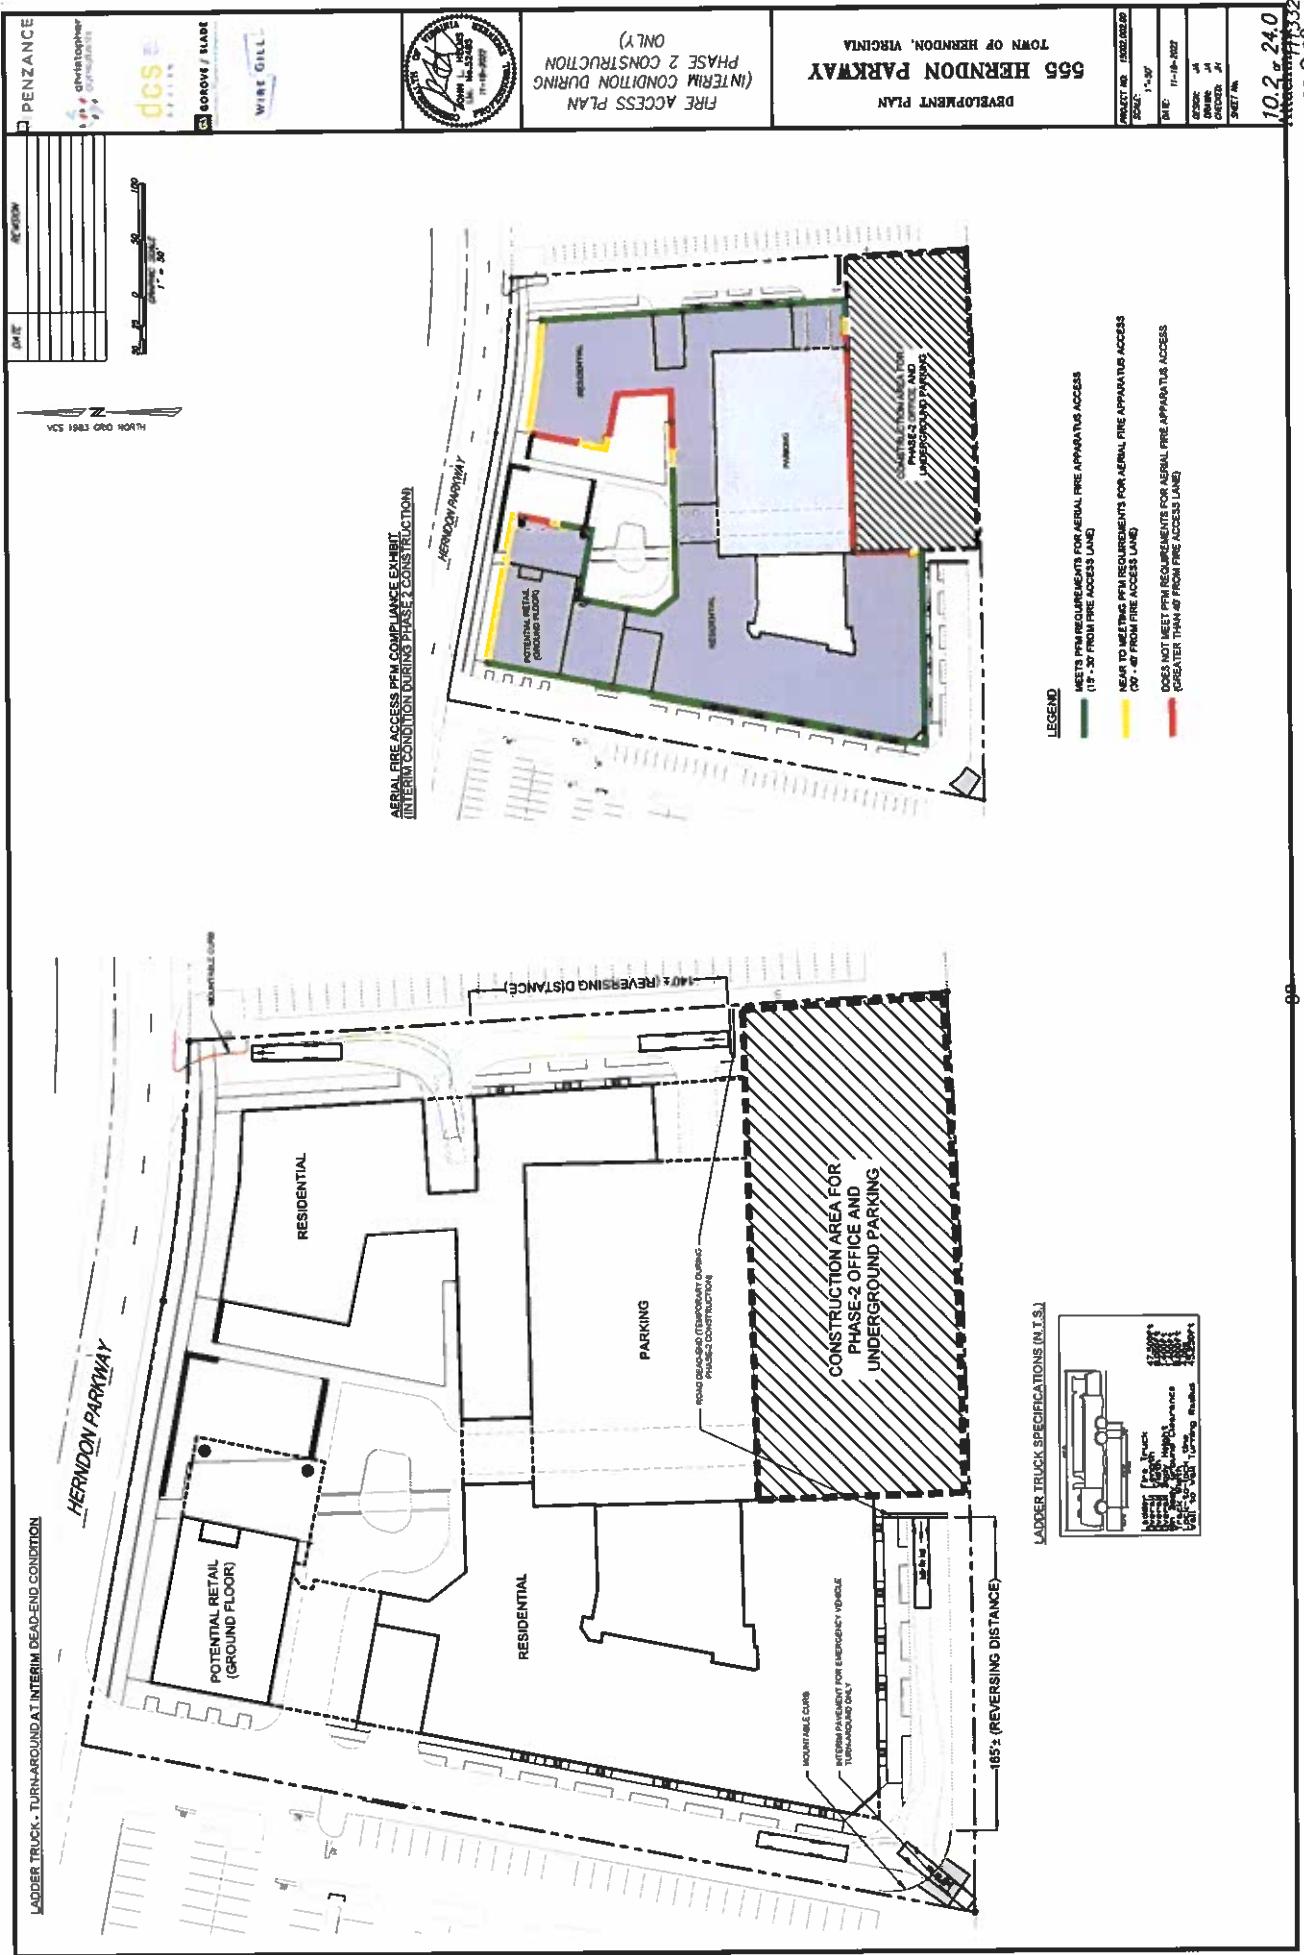

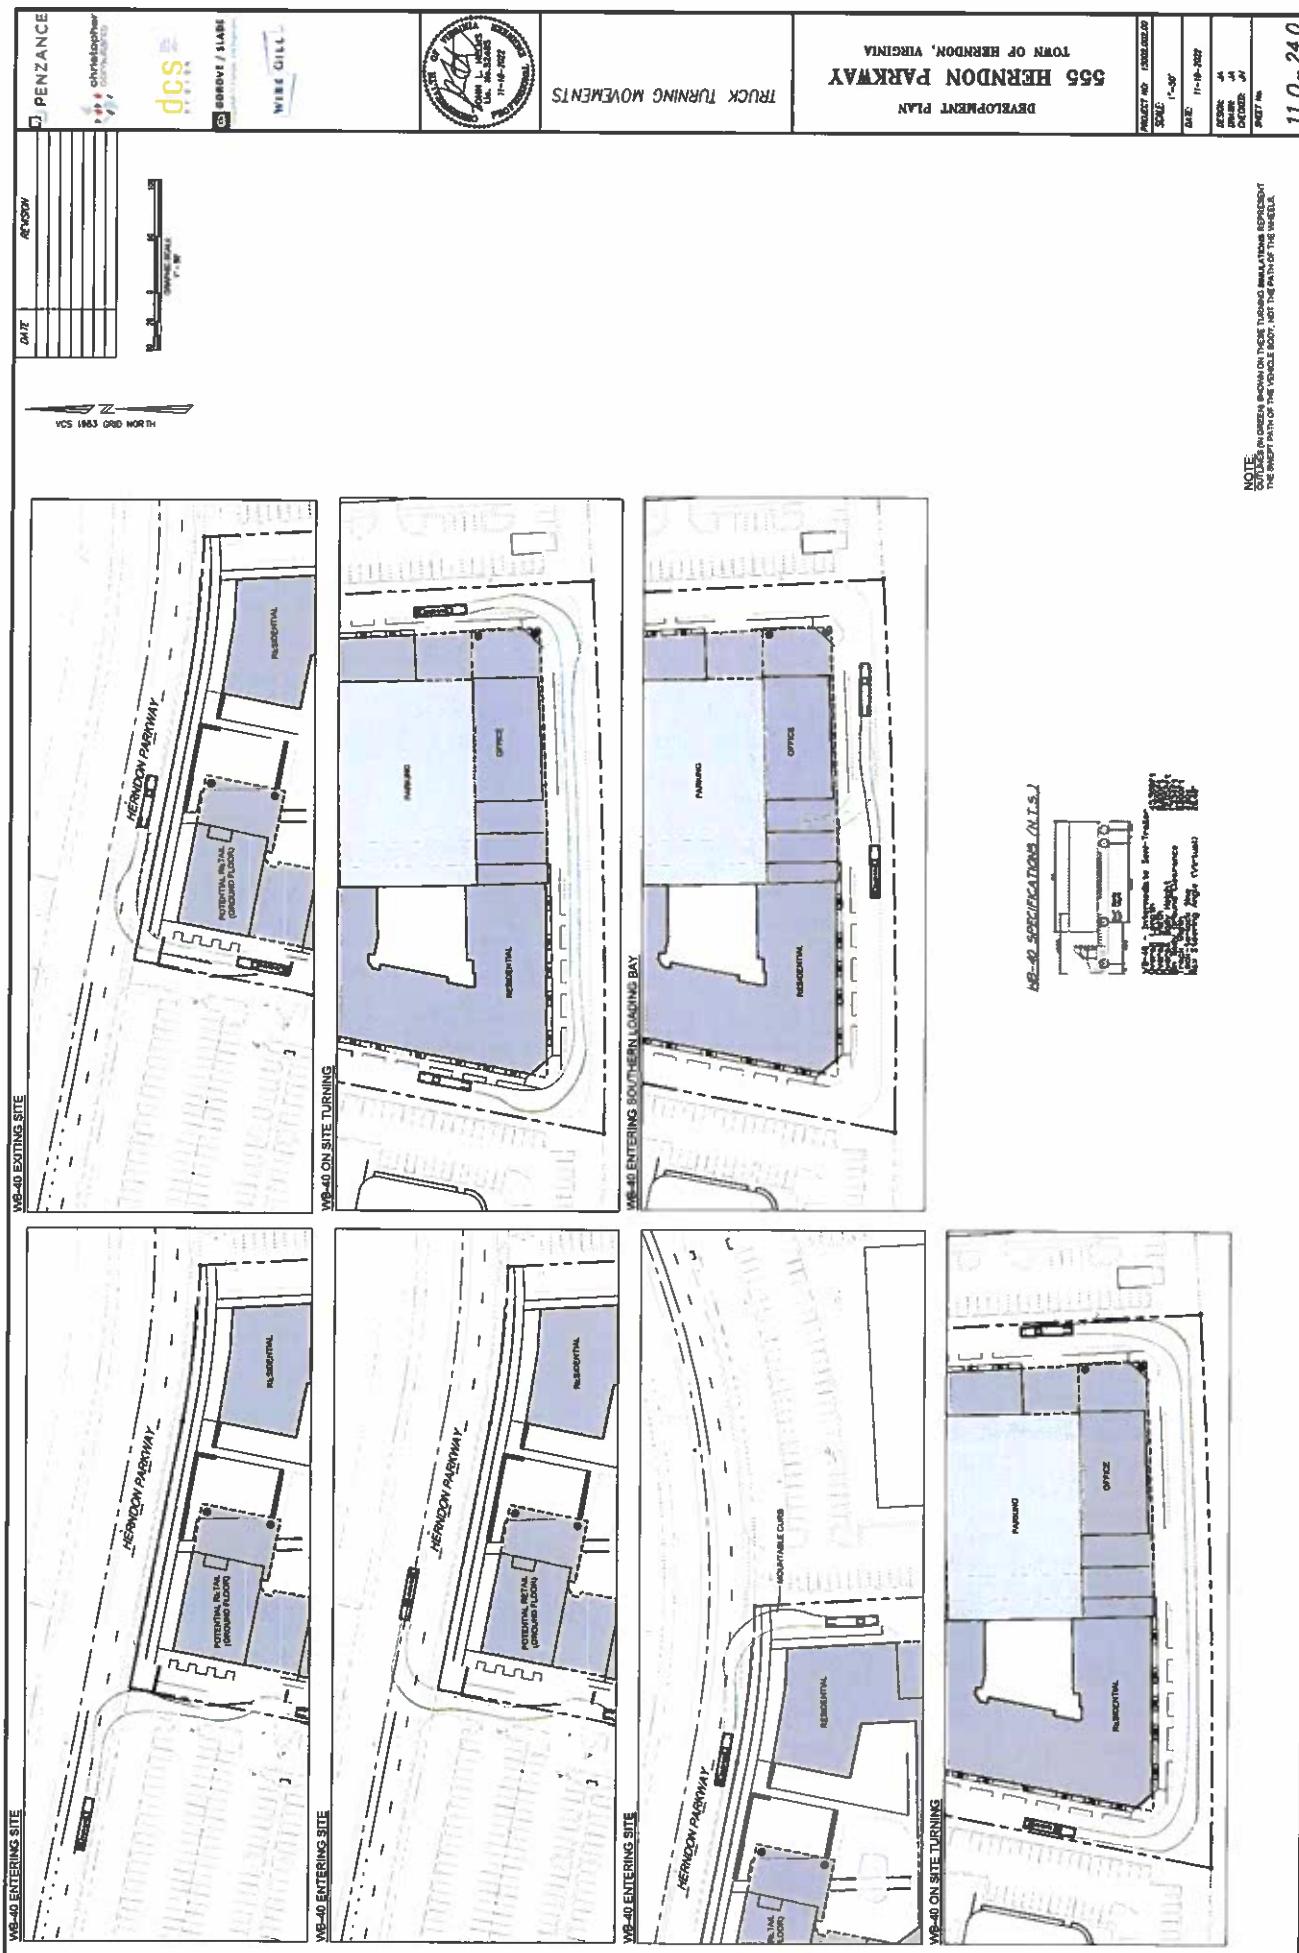

11.0 or 24.0
Attachment#3332
22-O-28

505 HERNDON PARKWAY
TOWN OF HERNDON, VIRGINIA
TRUCK TURNING MOVEMENTS
DEVELOPMENT PLAN

PROPERTY NO. F10002020
AS SHOWN
SCALE: 1:1000
DATE: 11-06-2007
NOTICE: DRIVING IN A CAR IS PROHIBITED
ON THE PROPERTY.
NOTE: GREEN SHADING INDICATES THE
PATH OF THE VEHICLE BODY, NOT THE PATH OF THE WHEELS.



PENZANCE

DIVERSITY OTHER
UNIVERSITY OF VIRGINIA
dcs
S U S T A I N A B I L I T Y
CORPORATE SLAB


WIRE GATE




DATE
RE-CORR

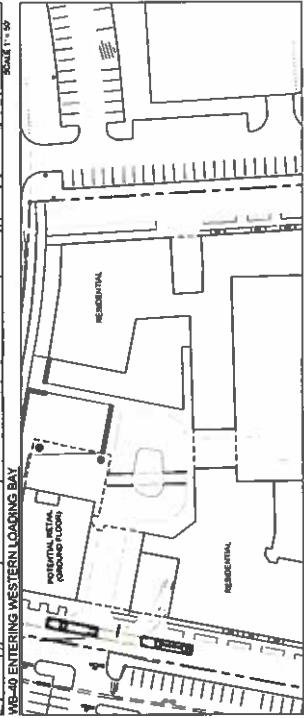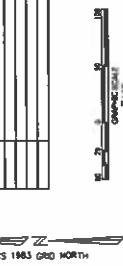


BOX TRUCK REVERSING INTO LOADING BAY / TRASH AREA

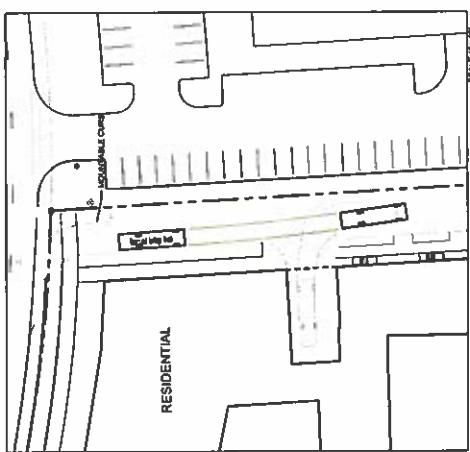

BOX TRUCK REVERSING INTO LOADING BAY / TRASH AREA

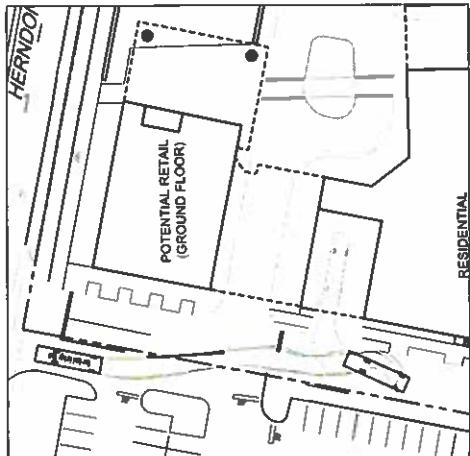

BOX TRUCK REVERSING INTO LOADING BAY / TRASH AREA

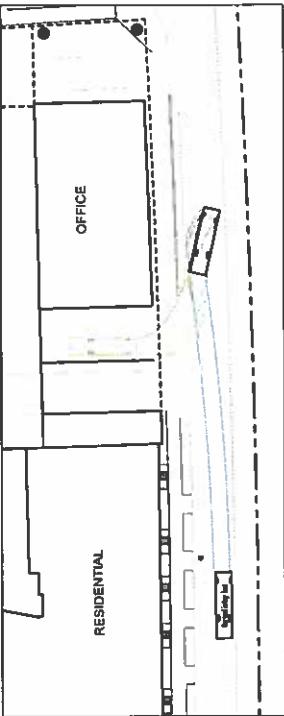


NOTE:
GREEN SHADING INDICATES THE
PATH OF THE VEHICLE BODY, NOT THE PATH OF THE WHEELS.

11.1a 24.0
Attachment 332
22-O-28

PENZANCE		Christopher Engineering	DCS Engineering	SHANE / SLADE	WIRE GILL	555 HENDON PARKWAY DEVELOPMENT PLAN TOWN OF HENDON, VIRGINIA	SOLD AS SHOWN DATE: 11-16-2022 ACRE: .45 DEPTH: 44 BREADTH: 44 COURTYARD: 44 STREET: 44
DATE:	ATTACHMENT						
<p>VCS 1983 GRID NORTH</p>							
<p>ROUTE 11 W</p>							
<p>NOTE: OUTLINES IN GREEN ARE TURNABOUT BOUNDARIES REPRESENTING THE SWEEP PATH OF THE VEHICLE, NOT THE PATH OF THE VEHICLE.</p>							

11.2 or 24.0
Attachment#1332
22-O-28

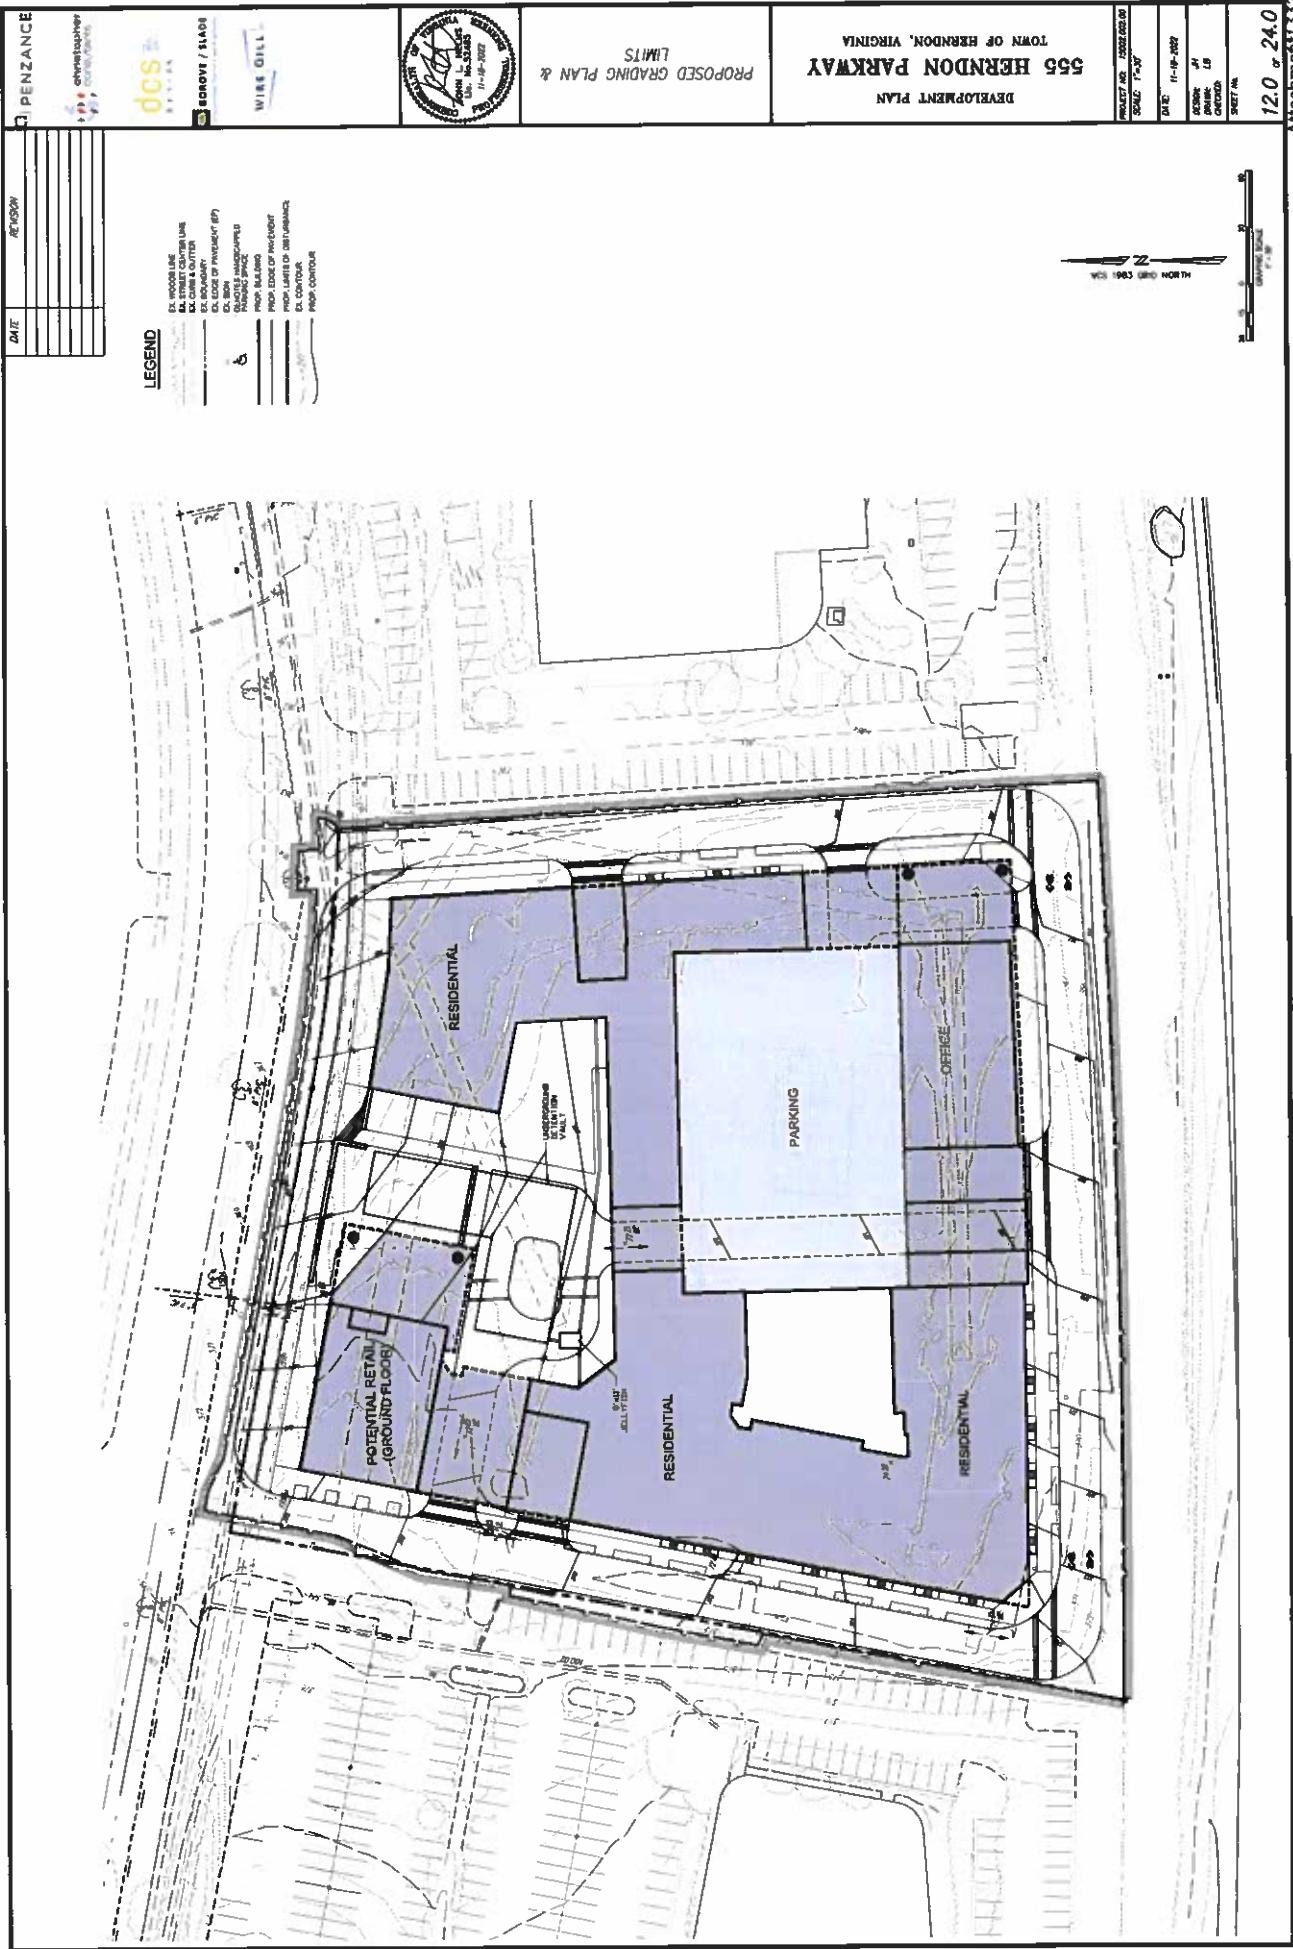



Attachment#1332
22-O-28

NOTE: GARAGE DESIGN IS CONCEPTUAL AND CAN BE MODIFIED AT TIME OF SITE PLAN FOR EACH BUILDING PHASE ON THE CONDITION THAT THE MINIMUM REQUIRED RATE FOR EACH USE IS PROVIDED.

PENZANCE
THE BRITISH
CHIROPRACTIC
ASSOCIATION



PARKING PLAN

555 HERNNDON PARKWAY
LEARDERMENT PLAN
TOWN OF HERNNDON, VIRGINIA

PRODUCT #:	145000-000-000
SCD#:	AS NOTED
DATE:	11-16-2029
REASON:	0x3
OWNER:	0x3
CREATOR:	0x3
SHEET NO.	

Attachment 332



NOTE: 1. GARAGE DESIGN IS CONCEPTUAL AND CAN BE MODIFIED AT TIME OF SITE PLAN FOR EACH BUILDING PHASE ON THE CONDITION THAT THE AMOUNT RECORDED RATE FOR EACH USE IS PROVIDED.

NOTE: GARAGE DESIGN IS CONCEPTUAL AND CAN BE MODIFIED AT TIME OF SITE PLAN FOR EACH BUILDING PHASE ON THE CONDITION THAT THE MINIMUM REQUIRED RATE FOR EACH USE IS PROVIDED.

PENZANCE

Christopher

GOBVE / HAD

WIRE GILL

dcS

TOWN OF HERNDON, VIRGINIA

555 HERNDON PARKWAY

DEVELOPMENT PLAN

ALL-TERRAIN LAYOUT

PLANNING PLAN

REVISION

DATE

11-16-2022

SCALE 1"=60'

FLOOR - 3

SCALE 1"=60'

FLOOR - 2 EL. - 373'-75"

SCALE 1"=60'

FLOOR - 1 EL. - 363'

SCALE 1"=60'

FLOORS - 4-8


SCALE 1"=60'


TYPICAL OFFICE FLOOR


SCALE 1"=60'

14.1 - 24.0

VIS 1983 DRG NORTH

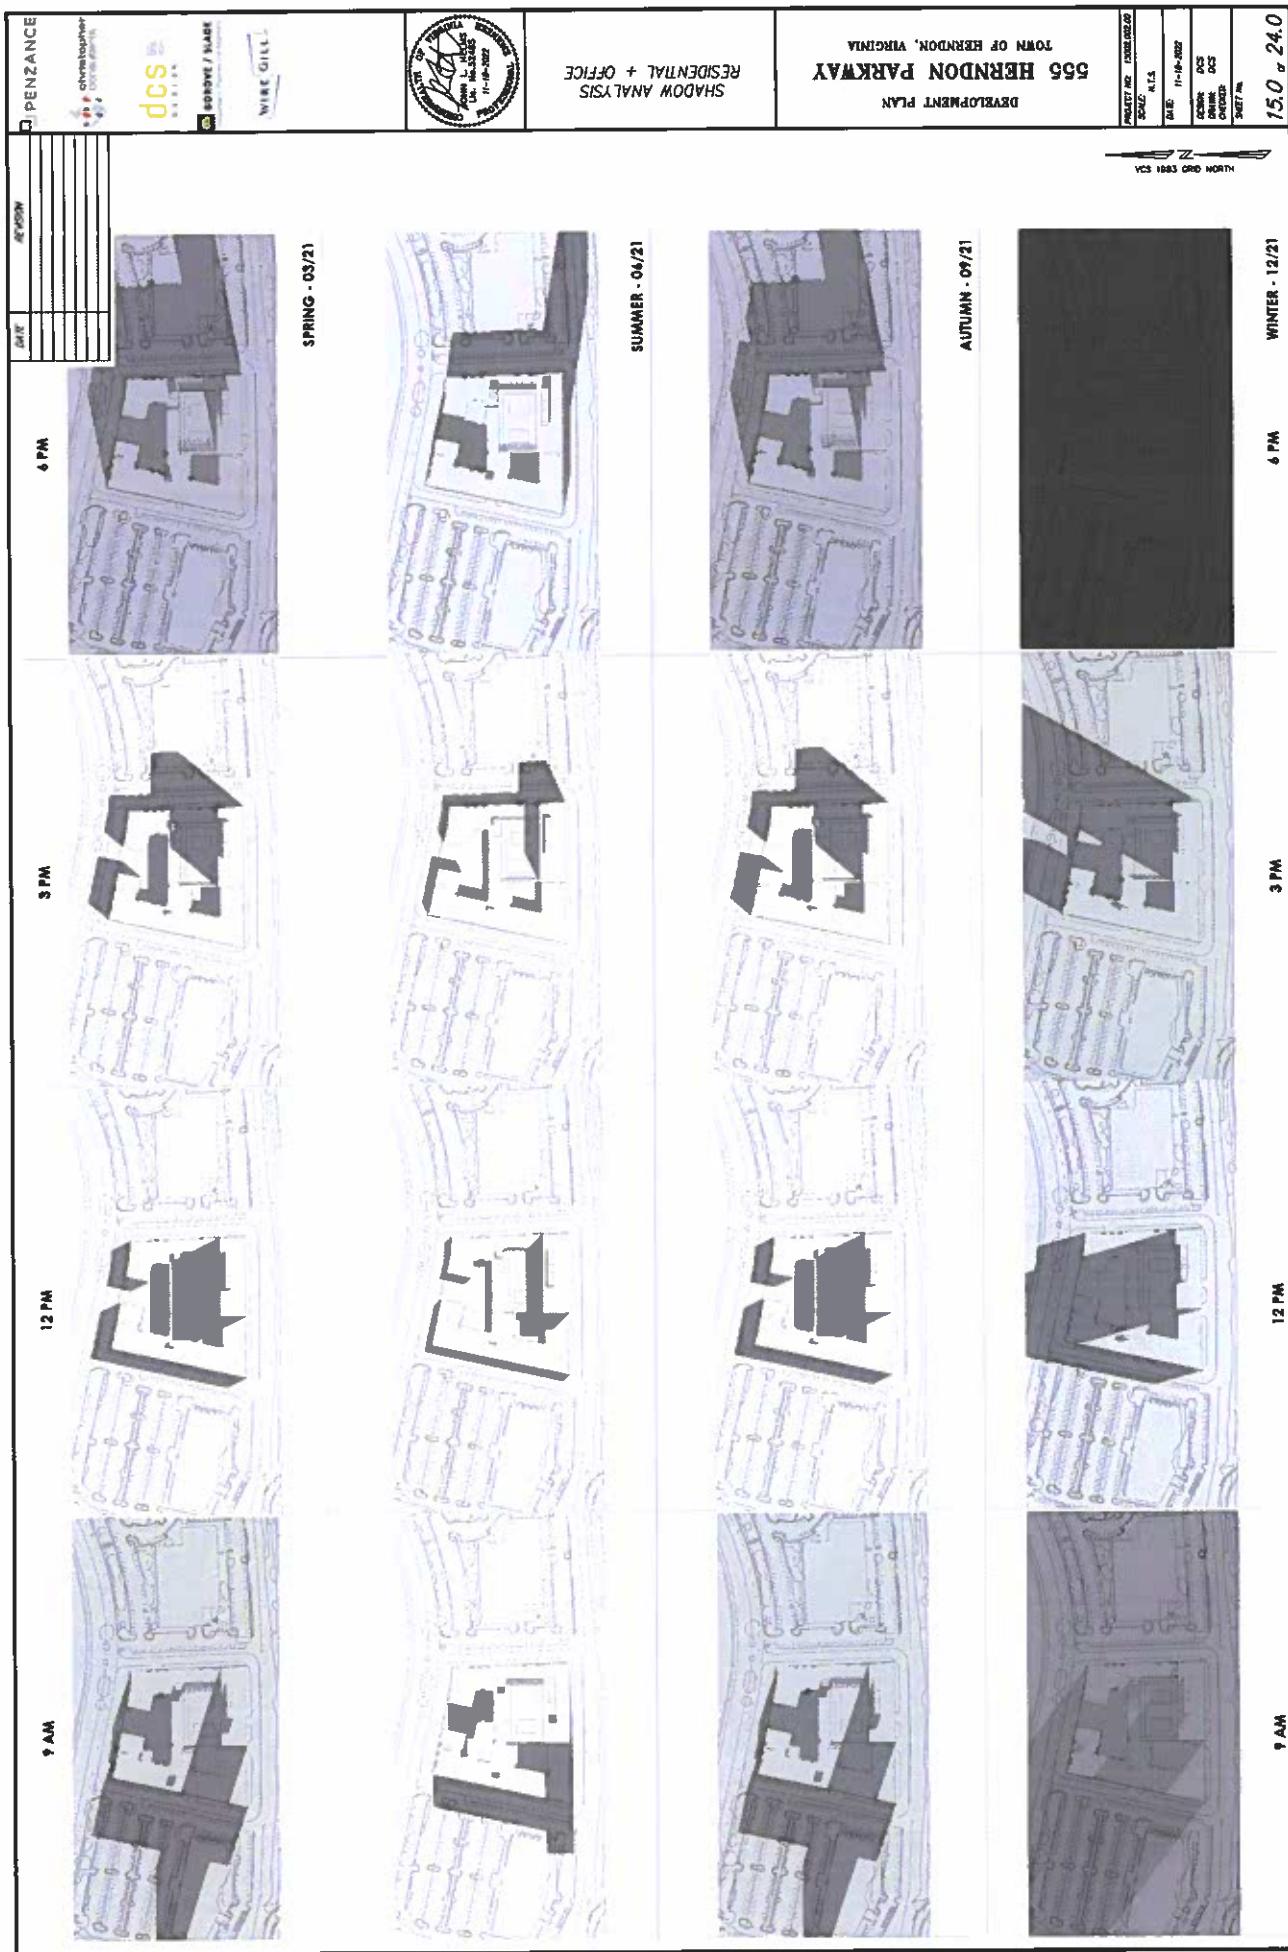

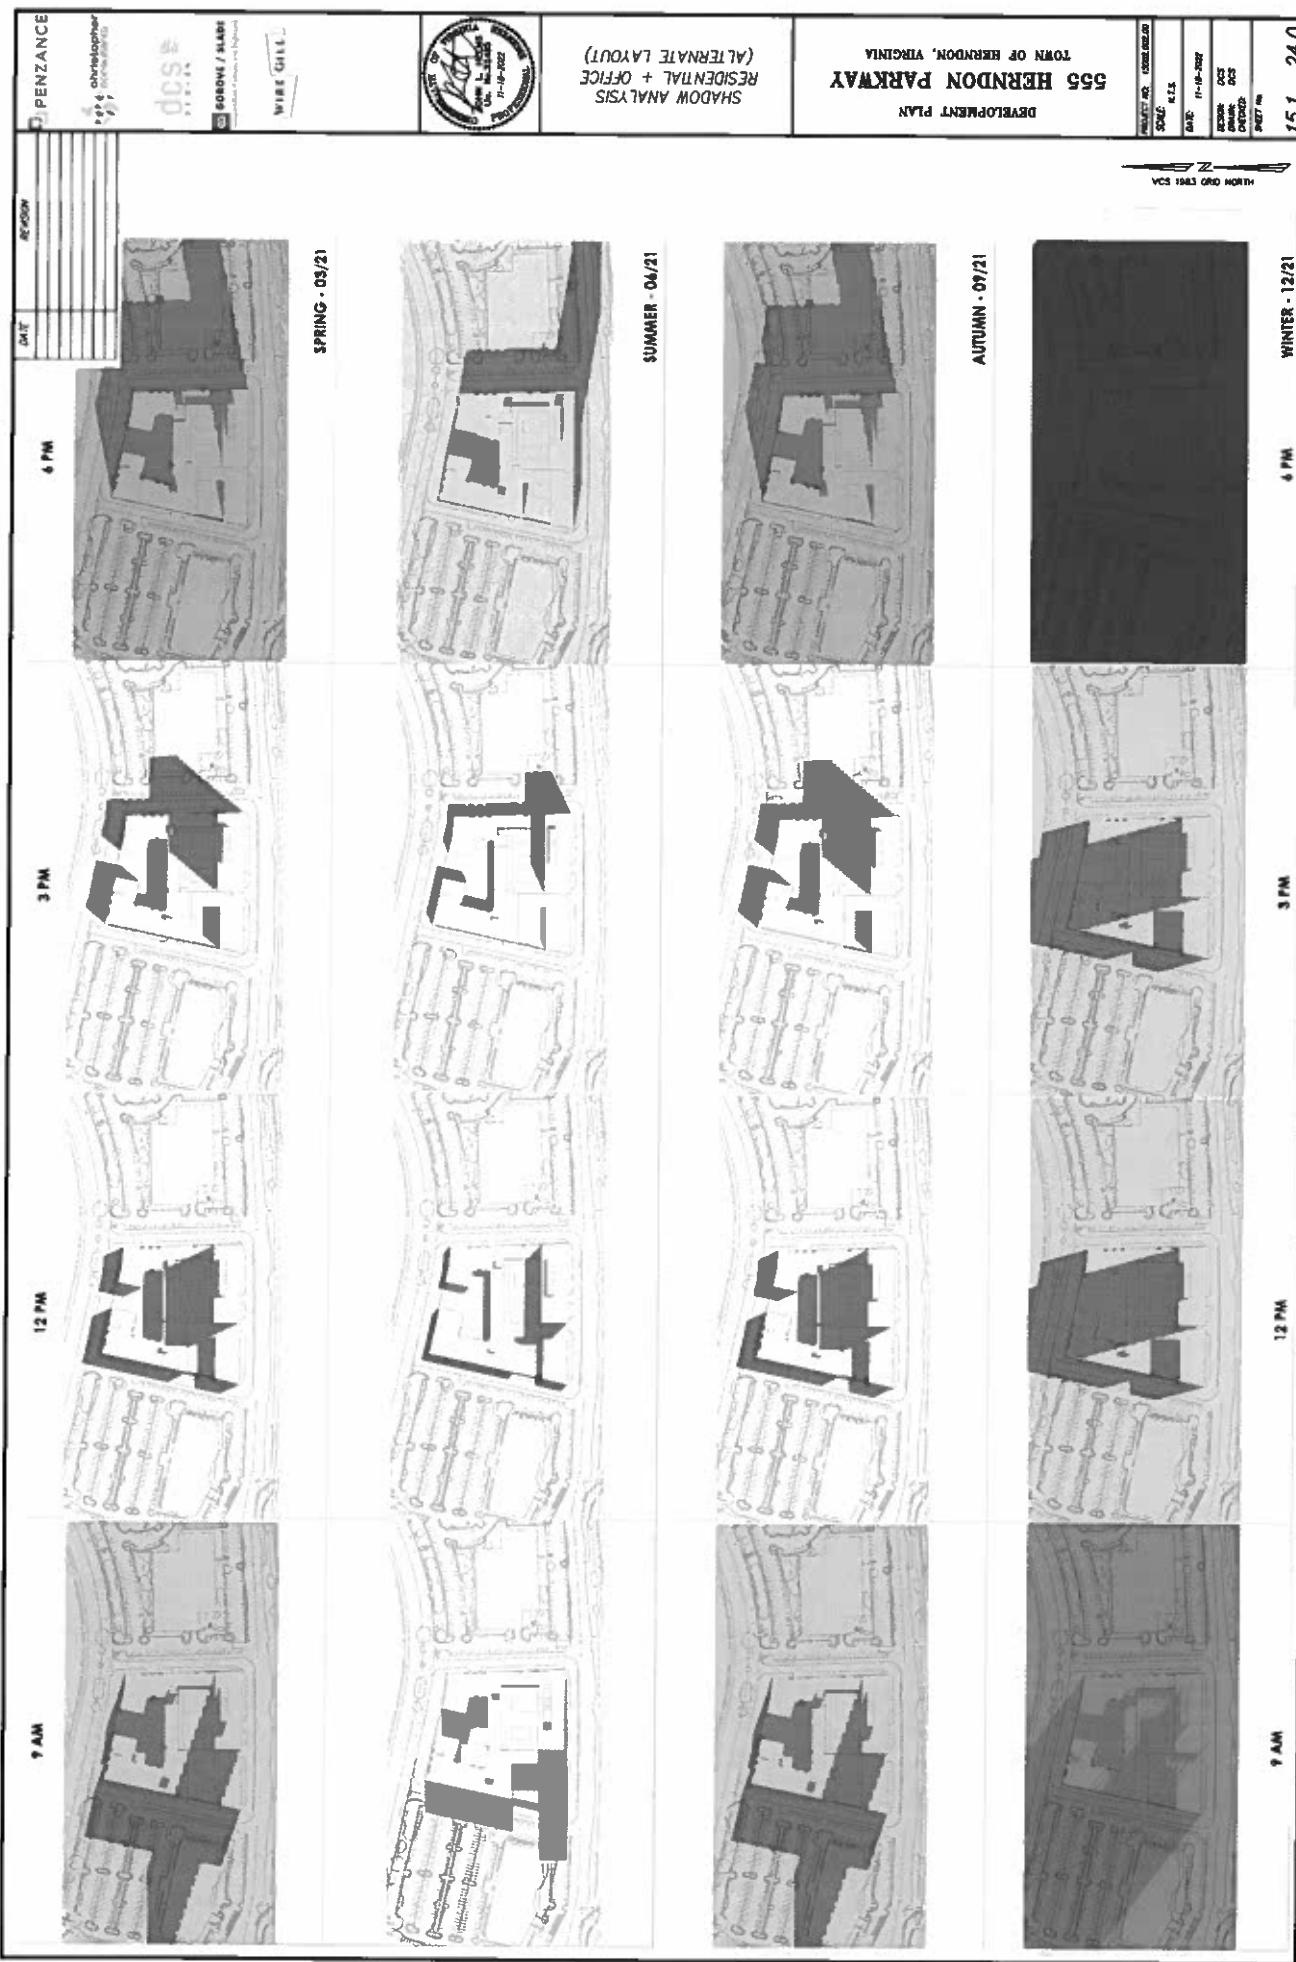

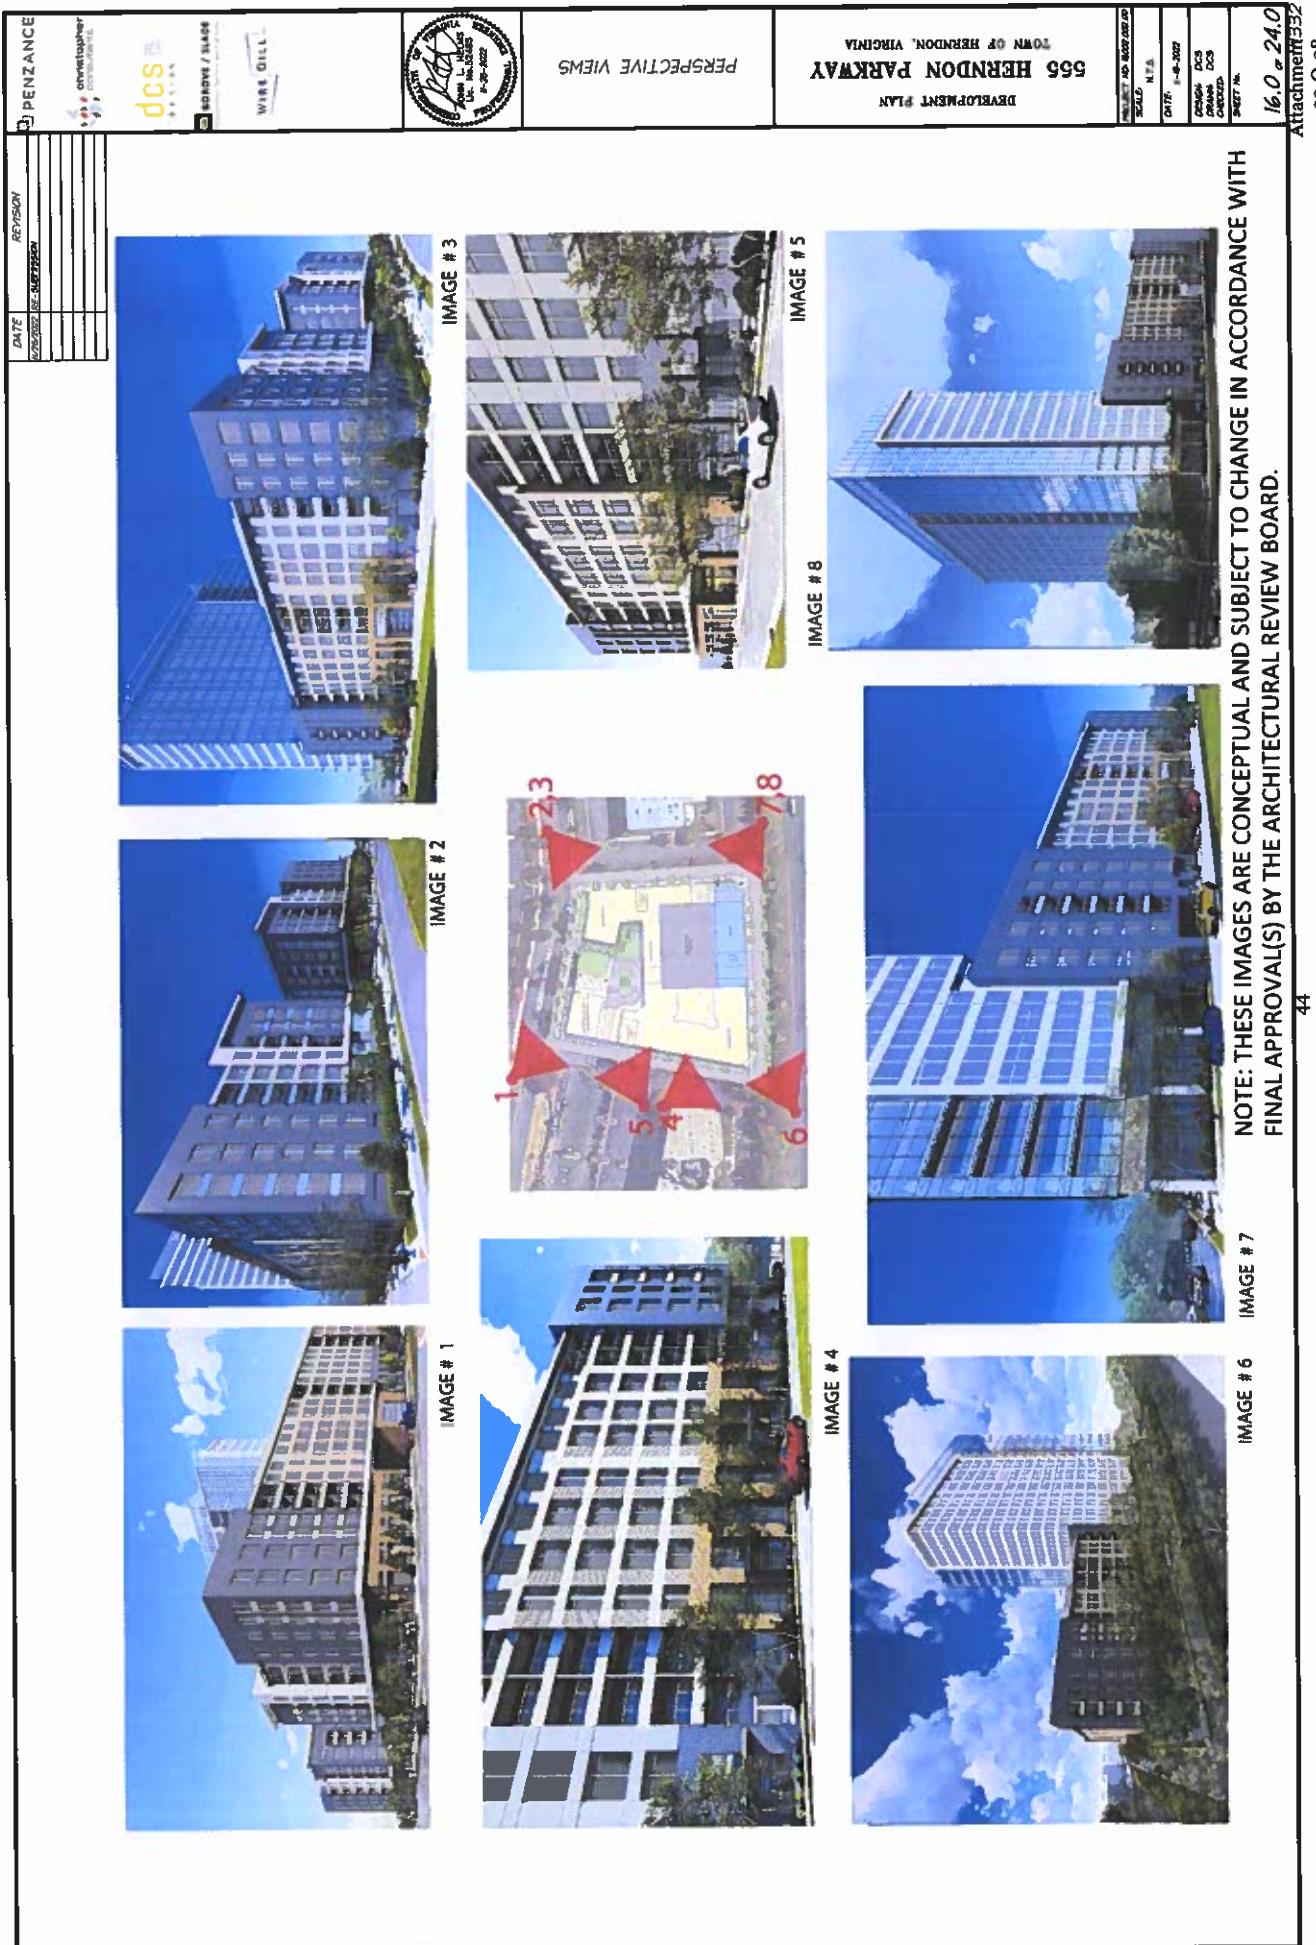


16.0 24.0
Attachment 332
22-O-28

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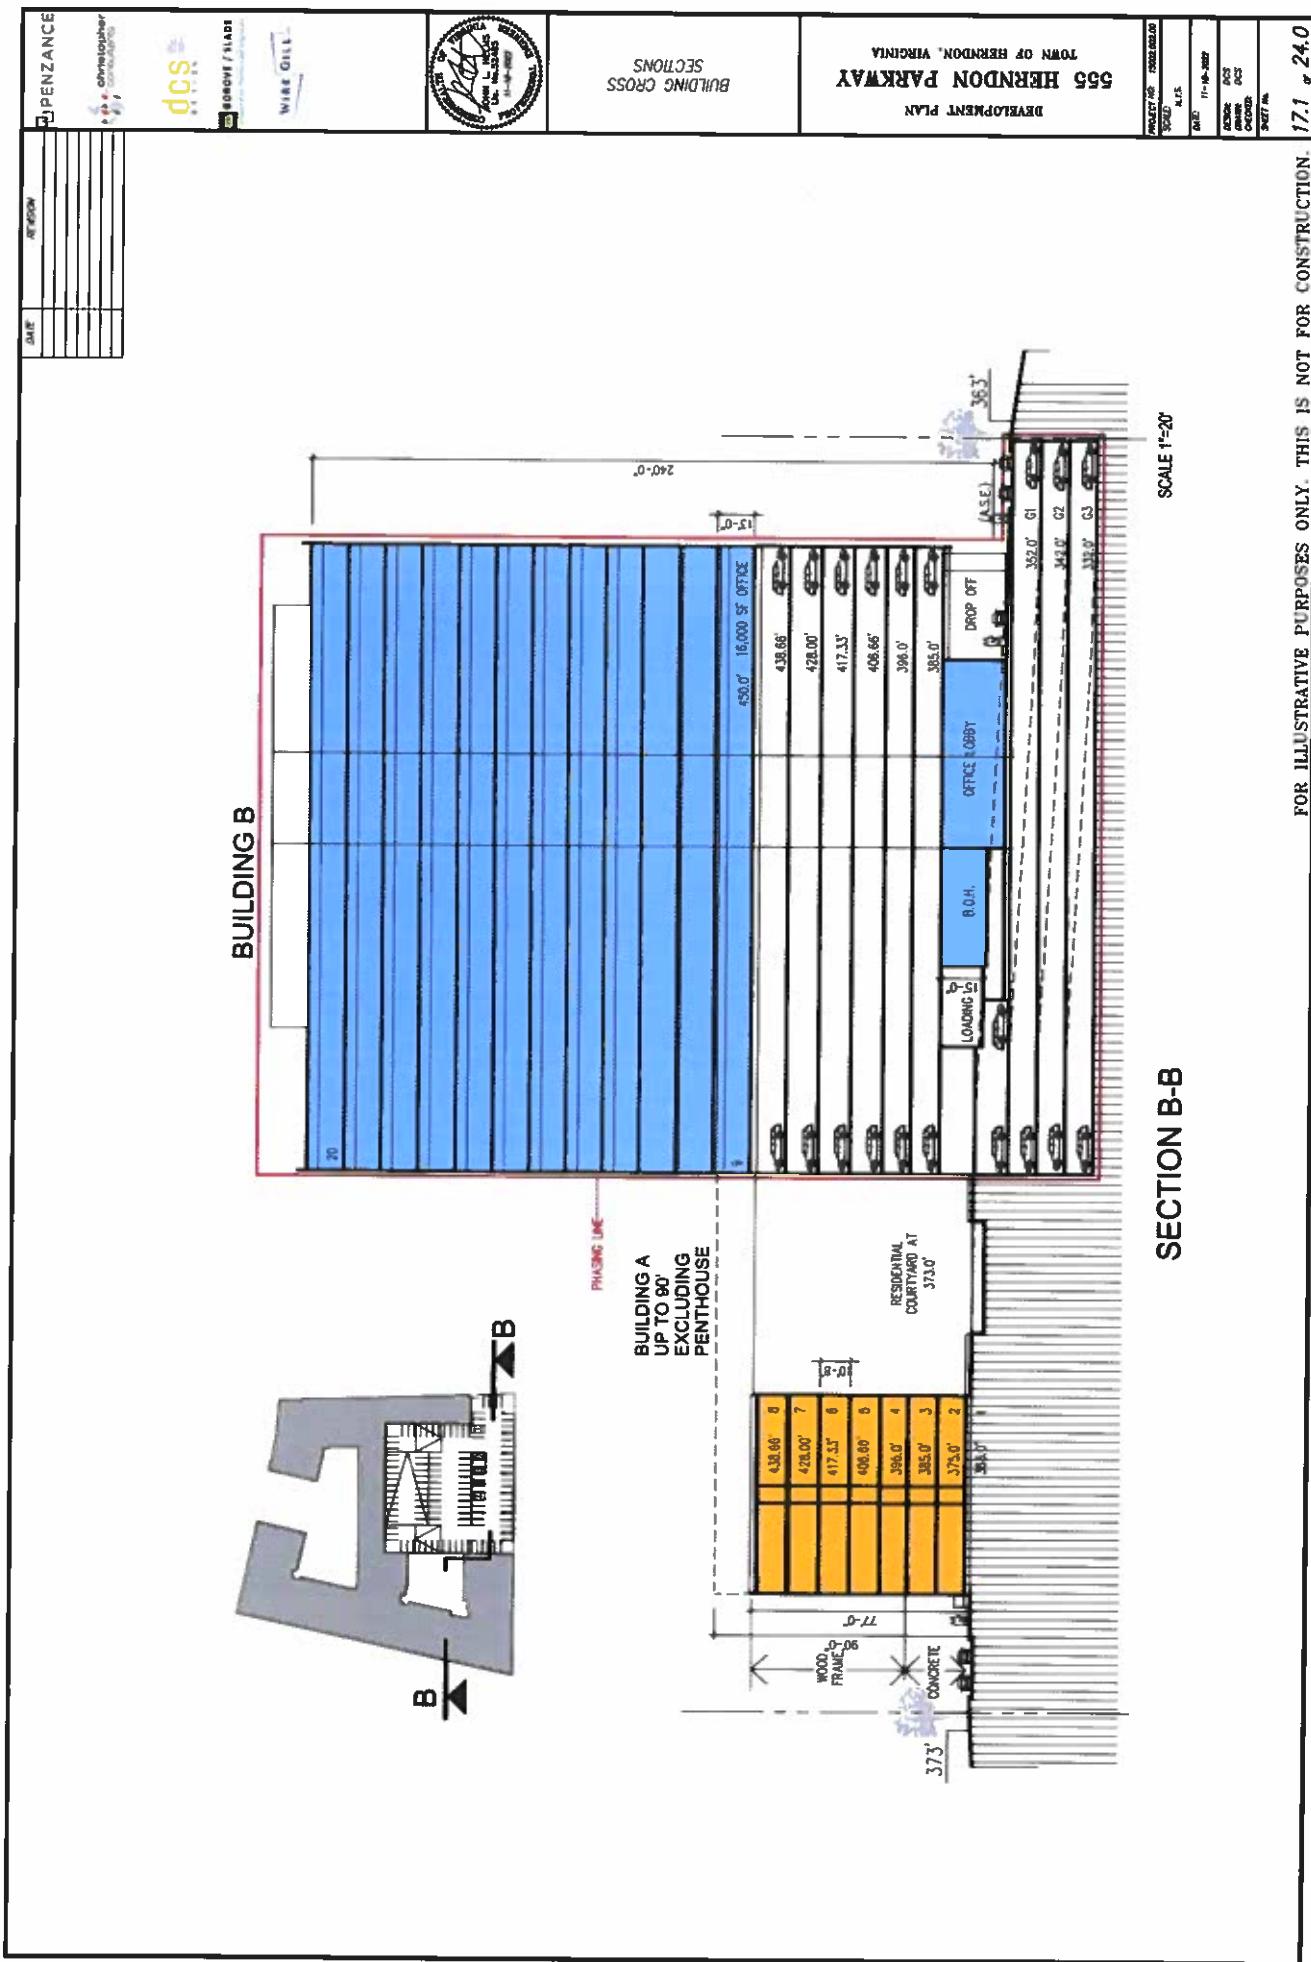
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IMAGE # 1 				
IMAGE # 2 				
IMAGE # 3 				
IMAGE # 4 				
IMAGE # 5 				
IMAGE # 6 				
IMAGE # 7 				
NOTE: THESE IMAGES ARE CONCEPTUAL AND SUBJECT TO CHANGE IN ACCORDANCE WITH FINAL APPROVAL(S) BY THE ARCHITECTURAL REVIEW BOARD.				

PENZANCE		PROJECT NO. 6002-002-00	
CHINABEAM INC.		SHEET NO. 3332	
dcs		DATE: 4-6-2022	
G. SORVET / SLAB		SCALE: N.T.S.	
WIRE GILL		DATE: 4-6-2022	
ARCHITECTURAL ELEVATIONS		CROSS-REF:	
55 HERNDON PARKWAY DEVELOPMENT PLAN		DCS - DCS - CDS - CDS	
TOWN OF HERNDON, VIRGINIA		SHEET NO. 22-O-28	
<p>WEST ELEVATION</p> <p>NORTH ELEVATION</p> <p>SOUTH ELEVATION</p> <p>EAST ELEVATION</p> <p>NOTE: THESE IMAGES ARE CONCEPTUAL AND SUBJECT TO CHANGE IN ACCORDANCE WITH FINAL APPROVAL(S) BY THE ARCHITECTURAL REVIEW BOARD.</p>			

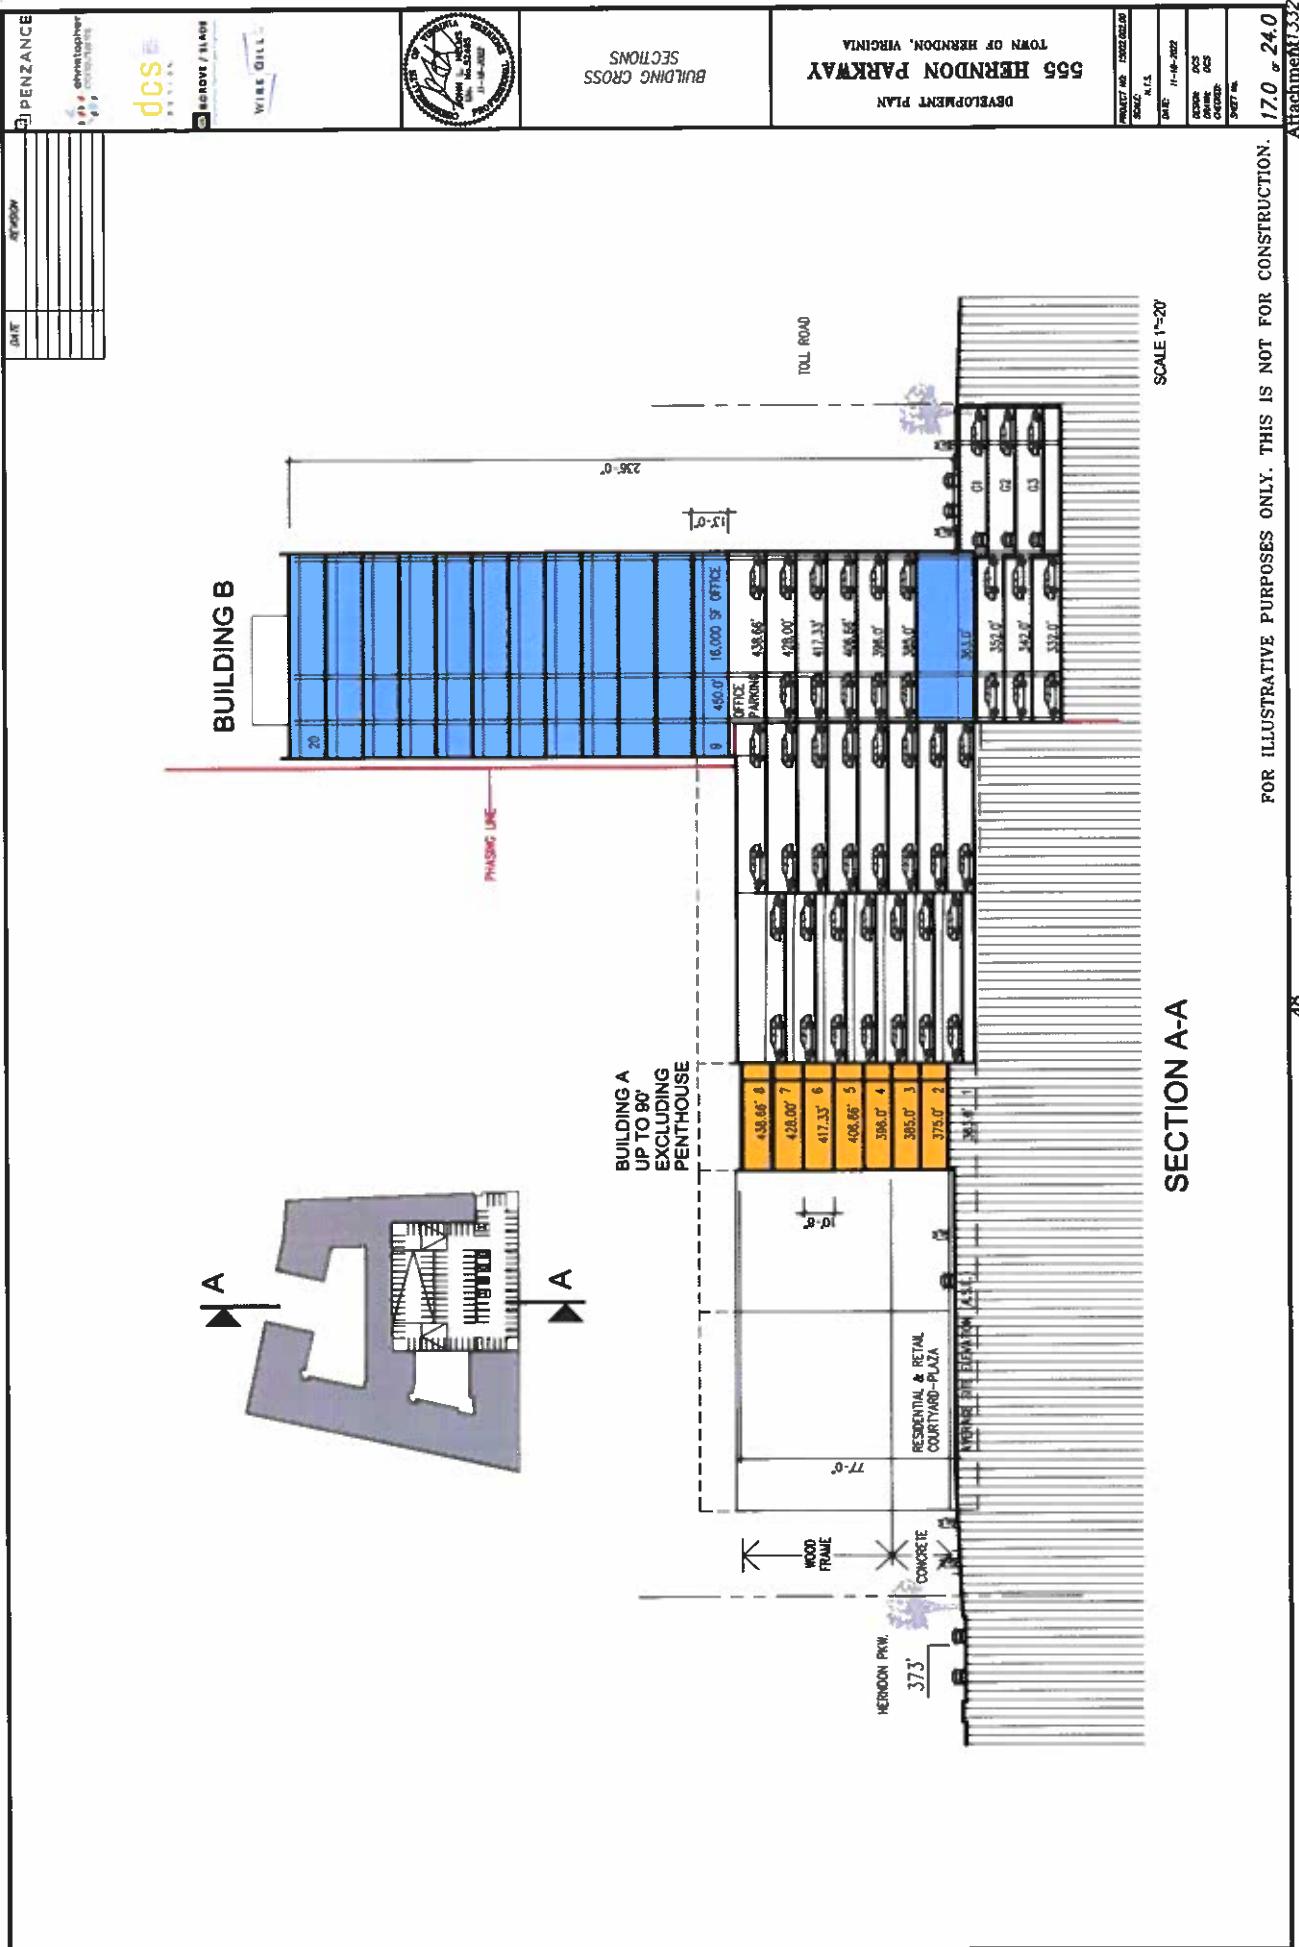


FOR ILLUSTRATIVE PURPOSES ONLY. THIS IS NOT FOR CONSTRUCTION.


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FOR ILLUSTRATIVE PURPOSES ONLY. THIS IS NOT FOR CONSTRUCTION.



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FOR ILLUSTRATIVE PURPOSES ONLY THIS IS NOT FOR CONSTRUCTION. 17.3 o 24. Attachment 13
22-0-08

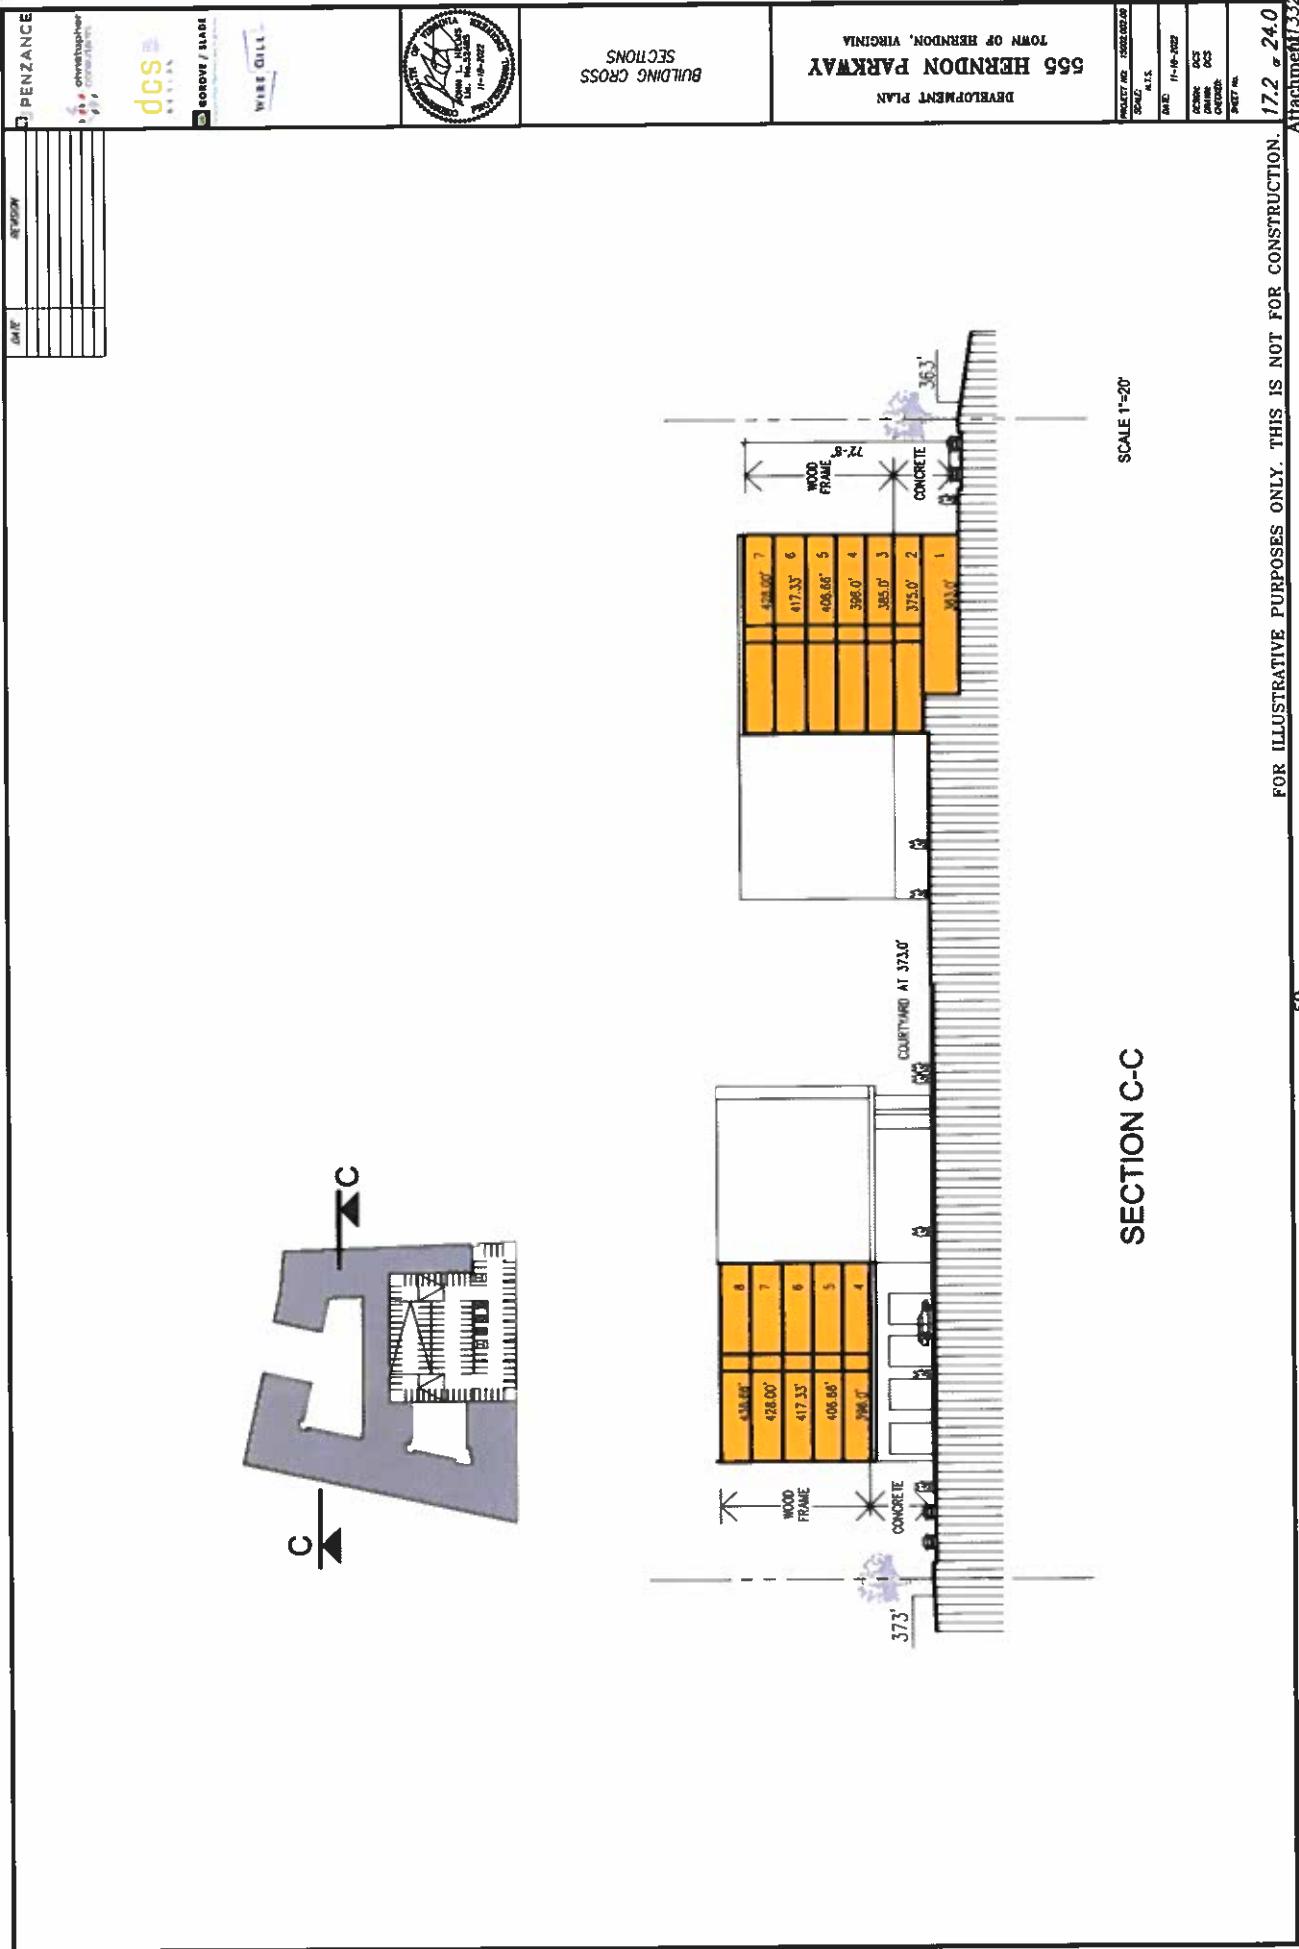SECTION C-C

555 HERNDON PARKWAY
TOWN OF HERNDON, VIRGINIA
DEVELOPMENT PLAN

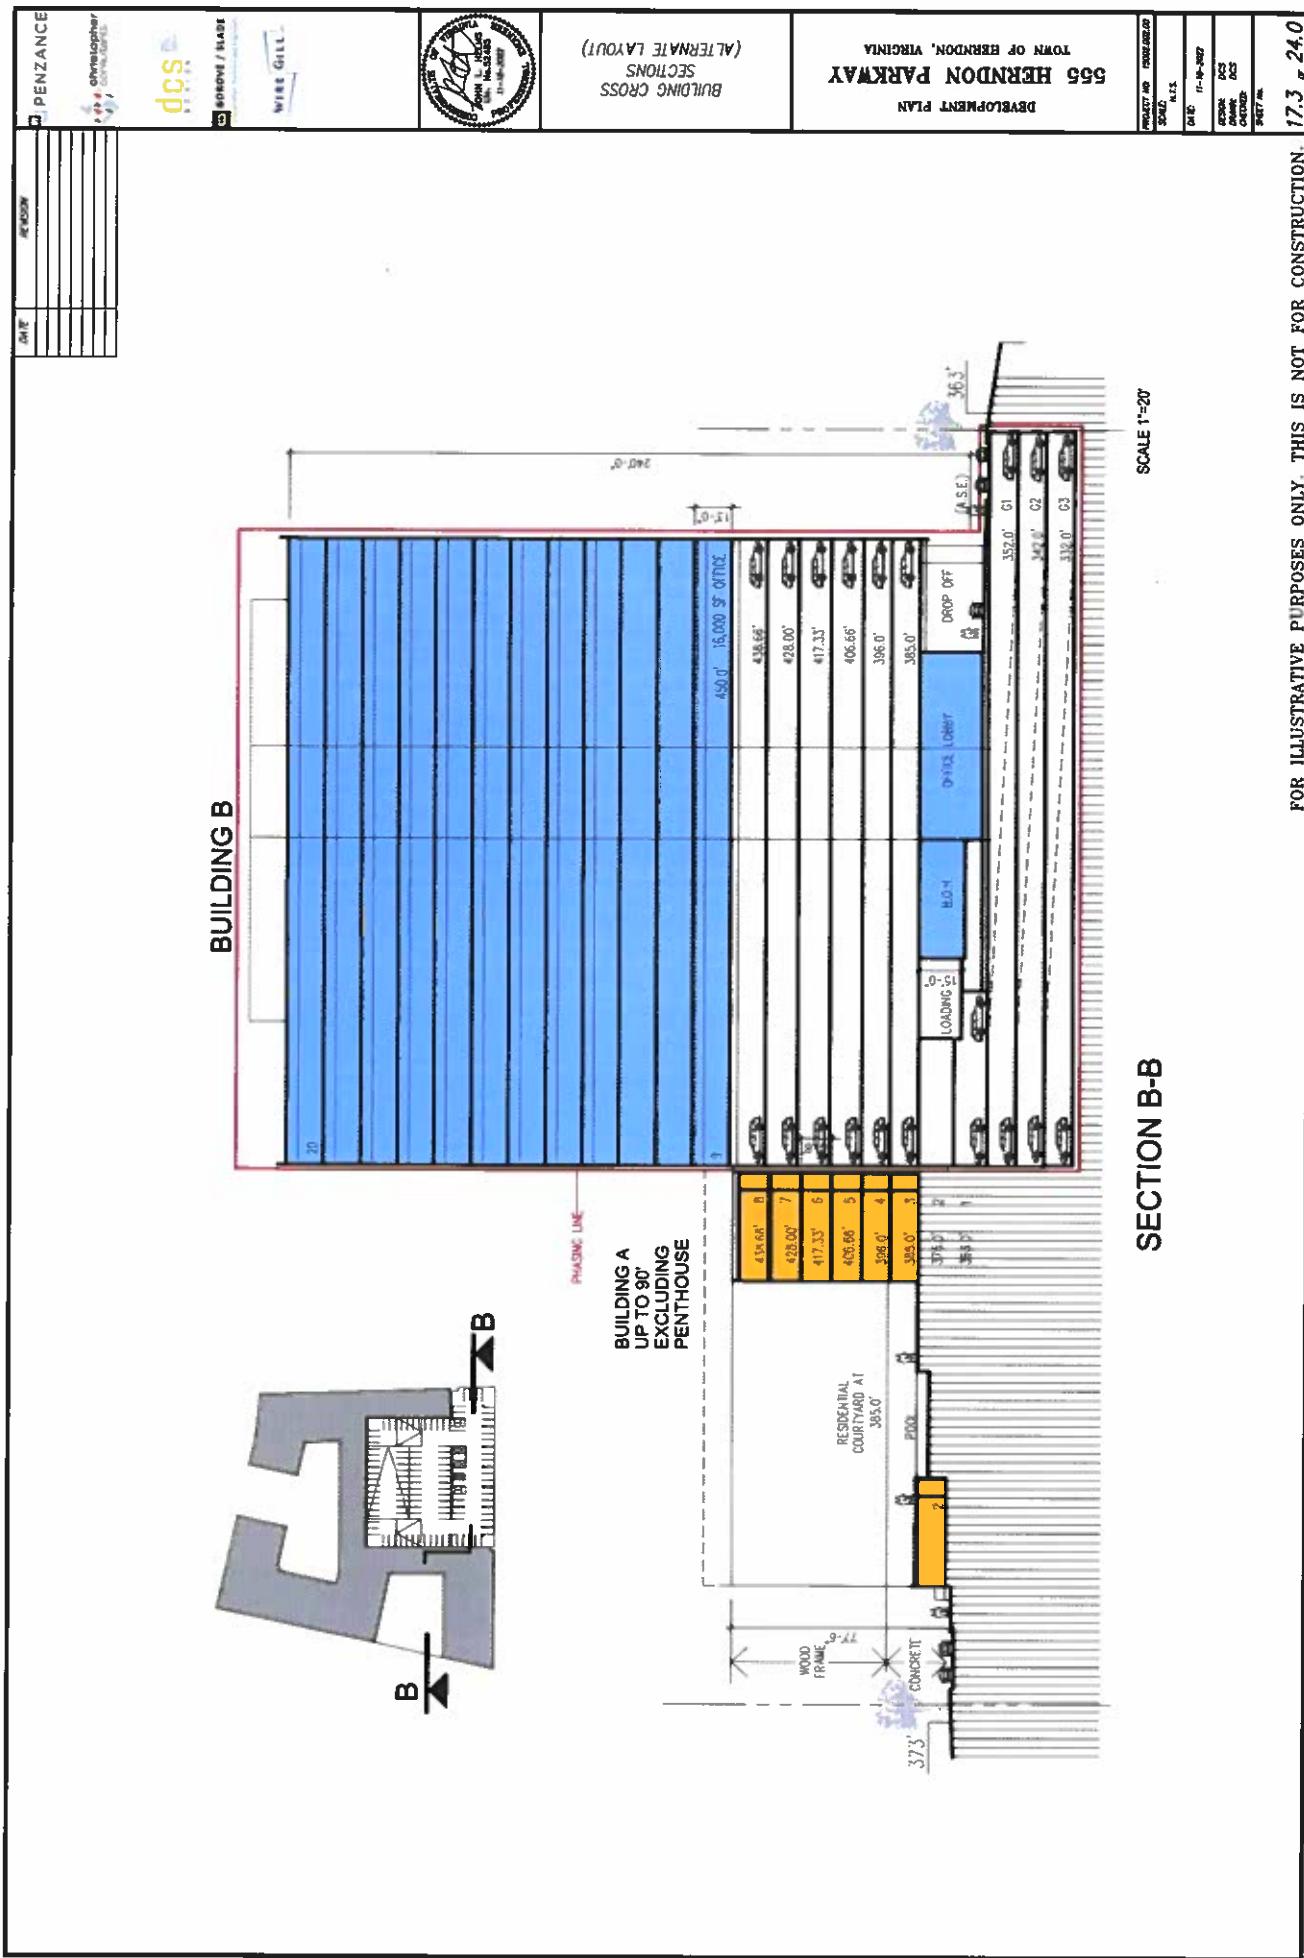BUILDING CROSS SECTIONS (ALTERNATE LAYOUT)

DCS DCS CONSULTING INC.
GROOVES / SLABS
WIRE GIRDERS

DATE: REVISION: **REVISION:**

PROJECT NO.: 100-000-000-000
SCALE: 1:16
DATE: 11-16-2022
DESIGNER: DCS
REVIEWER: DCS
CHECKER: DCS
SEALER: DCS

FOR ILLUSTRATIVE PURPOSES ONLY. THIS IS NOT FOR CONSTRUCTION. 17.4 x 24.0

3

17.4 - 24.0
Attachment 332
22-0-28

555 HERNDON PARKWAY
TOWN OF HERNDON, VIRGINIA
DEVELOPMENT PLAN

PROPOSED PRIVATE LOOP ROAD SECTION "A" CROSS SECTIONS

PROPOSED LOOP ROAD SEGMENT "A" SECTION C1-C1' STREETScape SECTION

PROPOSED LOOP ROAD SEGMENT "A" SECTION C1-C1' STREETScape SECTION

PROPOSED LOOP ROAD SEGMENT "A" SECTION B1-B1' STREETScape SECTION

PROPOSED LOOP ROAD SEGMENT "A" SECTION B-B' STREETScape SECTION

KEY PLAN

NOTE:
THE DEVELOPMENT PLAN IS TO PROVIDE MORE DETAILED INFORMATION ABOUT THE PROPERTY ROAD STREETSCAPES AND SECTION IT IS BASED ON THE SAME PROPOSED DEVELOPMENT CAN BE SHOWN IN OUR DEVELOPMENT PLAN SUBMISSION.
THIS SHEET IS FOR STREETSCAPE DESIGN CONSIDERATIONS ONLY.
NOT FOR CONSTRUCTION.

PROJECT NO. 1000-000-000-0000
SCALE: 1:128
DATUM: NAD 1983 HARN
DATE: 11-16-2022
OWNER: AB OWNER: AB
DESIGNER: AB
REVIEWER: AB
APPROVING OFFICER: AB
DATE APPROVED: 11-16-2022

555 HERNDON PARKWAY
TOWN OF HERNDON, VIRGINIA
DEVELOPMENT PLAN

PROJECT NO.: HERNDON-2022
SCALE: A.T.S.
DATE: 11-16-2022
REVISION: 44
DRAWER: 44
SHEET: 187

PENZANCE

KEY PLAN

NOTE:
THIS PLAN IS FOR THE USE OF THE DEVELOPER AND IS NOT AN APPROVED LAND USE PLAN.
IT IS PROVIDED AS A GUIDE FOR THE PROPOSED ROAD STREETS, ISLANDS AND
SECTION IT IS BASED ON THE SAME PROPOSED DEVELOPMENT PLAN AS
SHOWN IN THE DEVELOPMENT PLAN SUBMISSION DATED DECEMBER 15,
2021. THIS DEVELOPMENT PLAN IS FOR ILLUSTRATIVE PURPOSES
ONLY AND NOT FOR CONSTRUCTION.

BUILDING FACE

D1' PROPOSED LOOP ROAD SEGMENT "B" - SECTION D1'-D1' STREETSCAPE SECTION

BUILDING FACE

D' PROPOSED LOOP ROAD SEGMENT "B" - SECTION D-D' STREETSCAPE SECTION

BUILDING FACE

E' PROPOSED LOOP ROAD SEGMENT "C" - SECTION E1'-E' STREETSCAPE SECTION

BUILDING FACE

F' PROPOSED INTERNAL STREET - SECTION F-F'

G' PROPOSED INTERNAL STREET - SECTION G-G'

BUILDING FACE

E PROPOSED LOOP ROAD SEGMENT "C" - SECTION E-E'

THIS SHEET IS FOR STYLING CONSIDERATION ONLY

THIS PERTAINS TO THE PORTION OF THE LOOP ROAD

BUILDING FACE

D PROPOSED INTERNAL STREET - SECTION D-D'

BUILDING FACE

CROSS SECTION

PROPS. INTERNAL TRAIL / INTERNODEAL TRAIL / LOOP ROAD B & C CROSS SECTIONS

WIRE GILL

GROVE / SLADE

drivethrough


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RENOV


DATE


18.1 of 24.0


Attachment 1


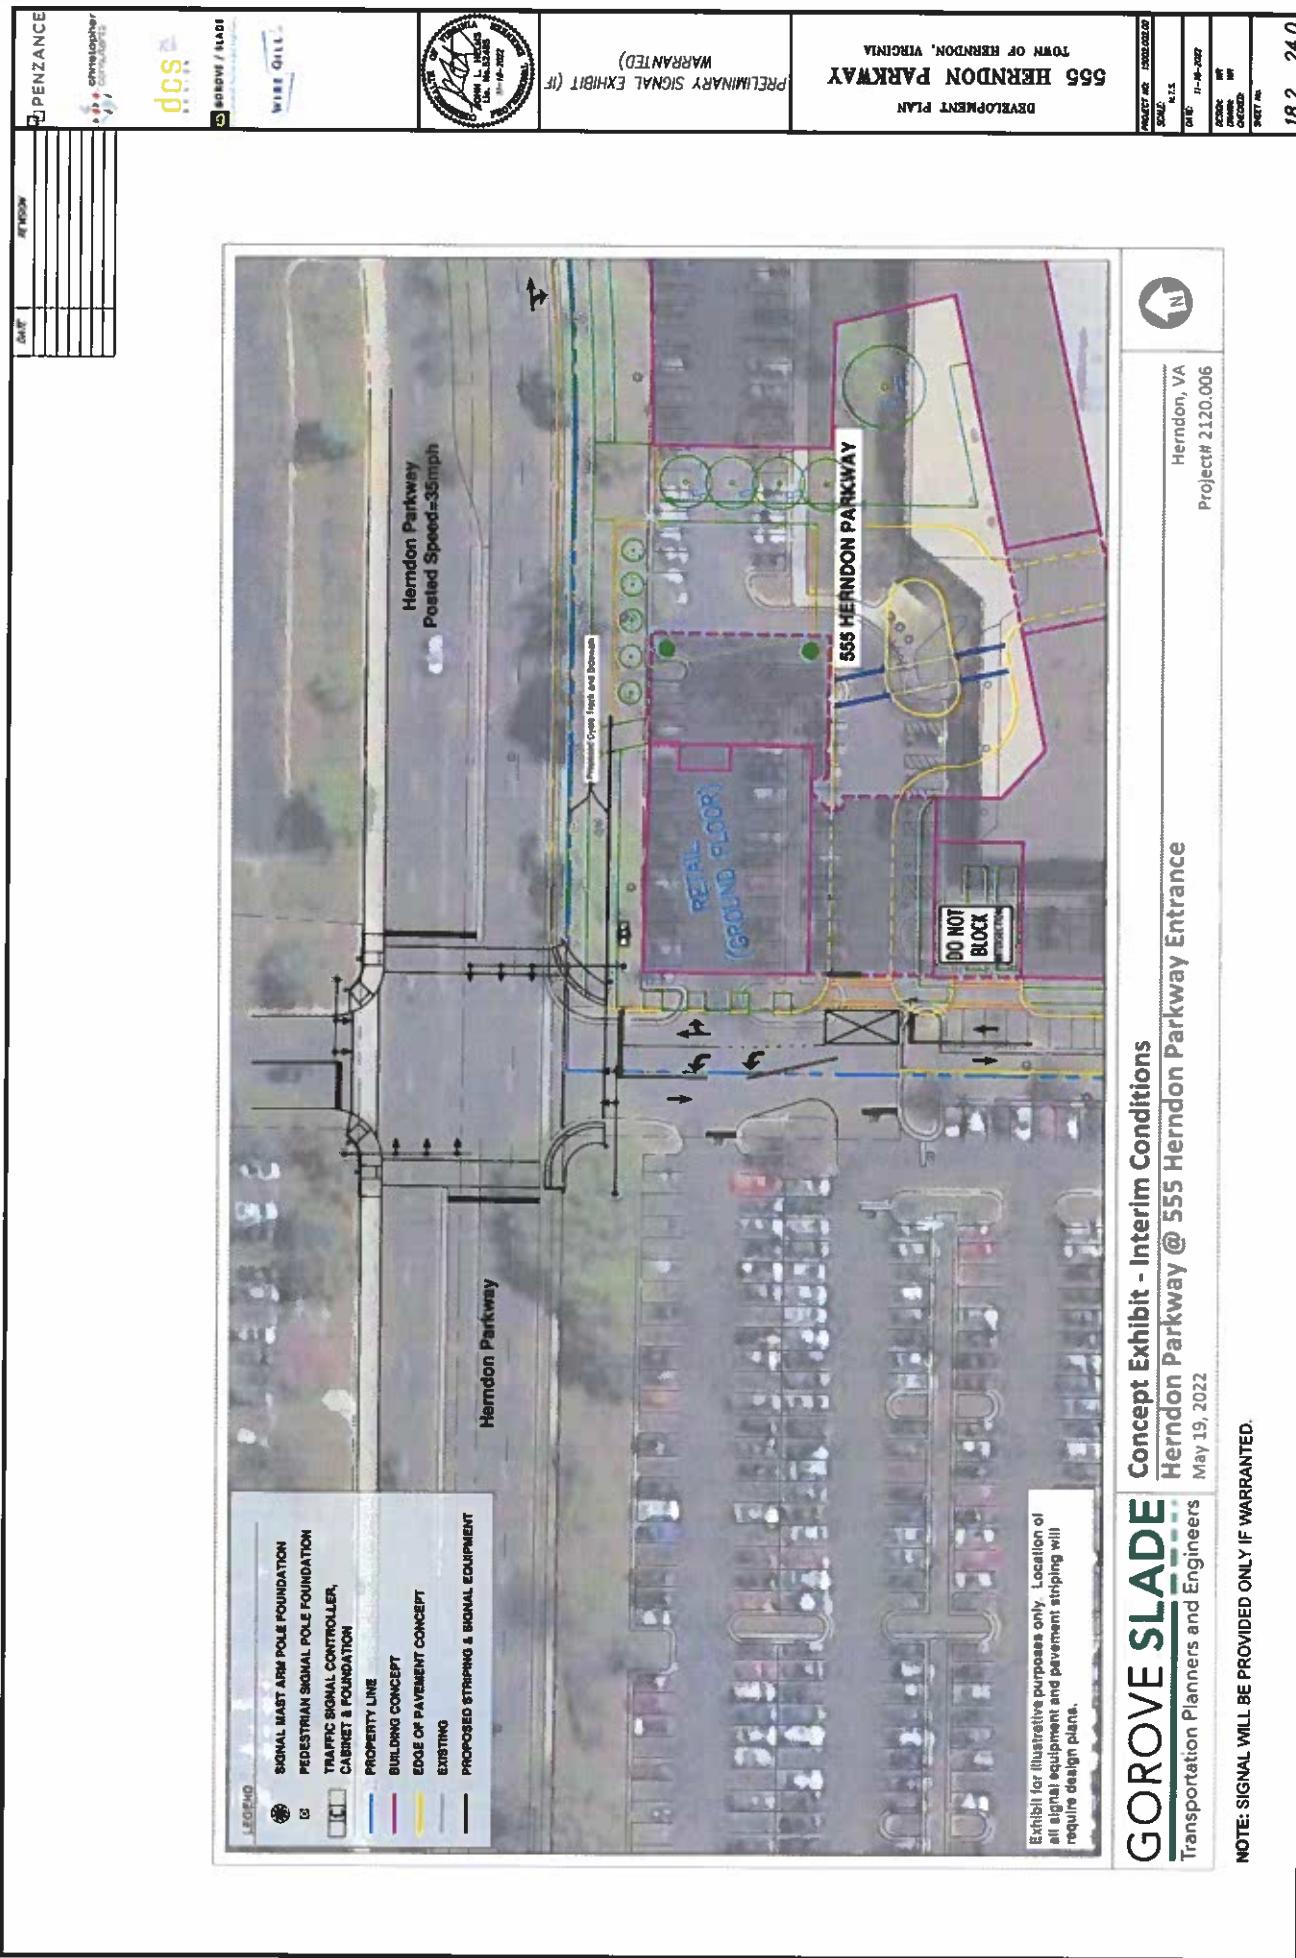


18.2 or 24.0
Attachment N 332
22-O-282

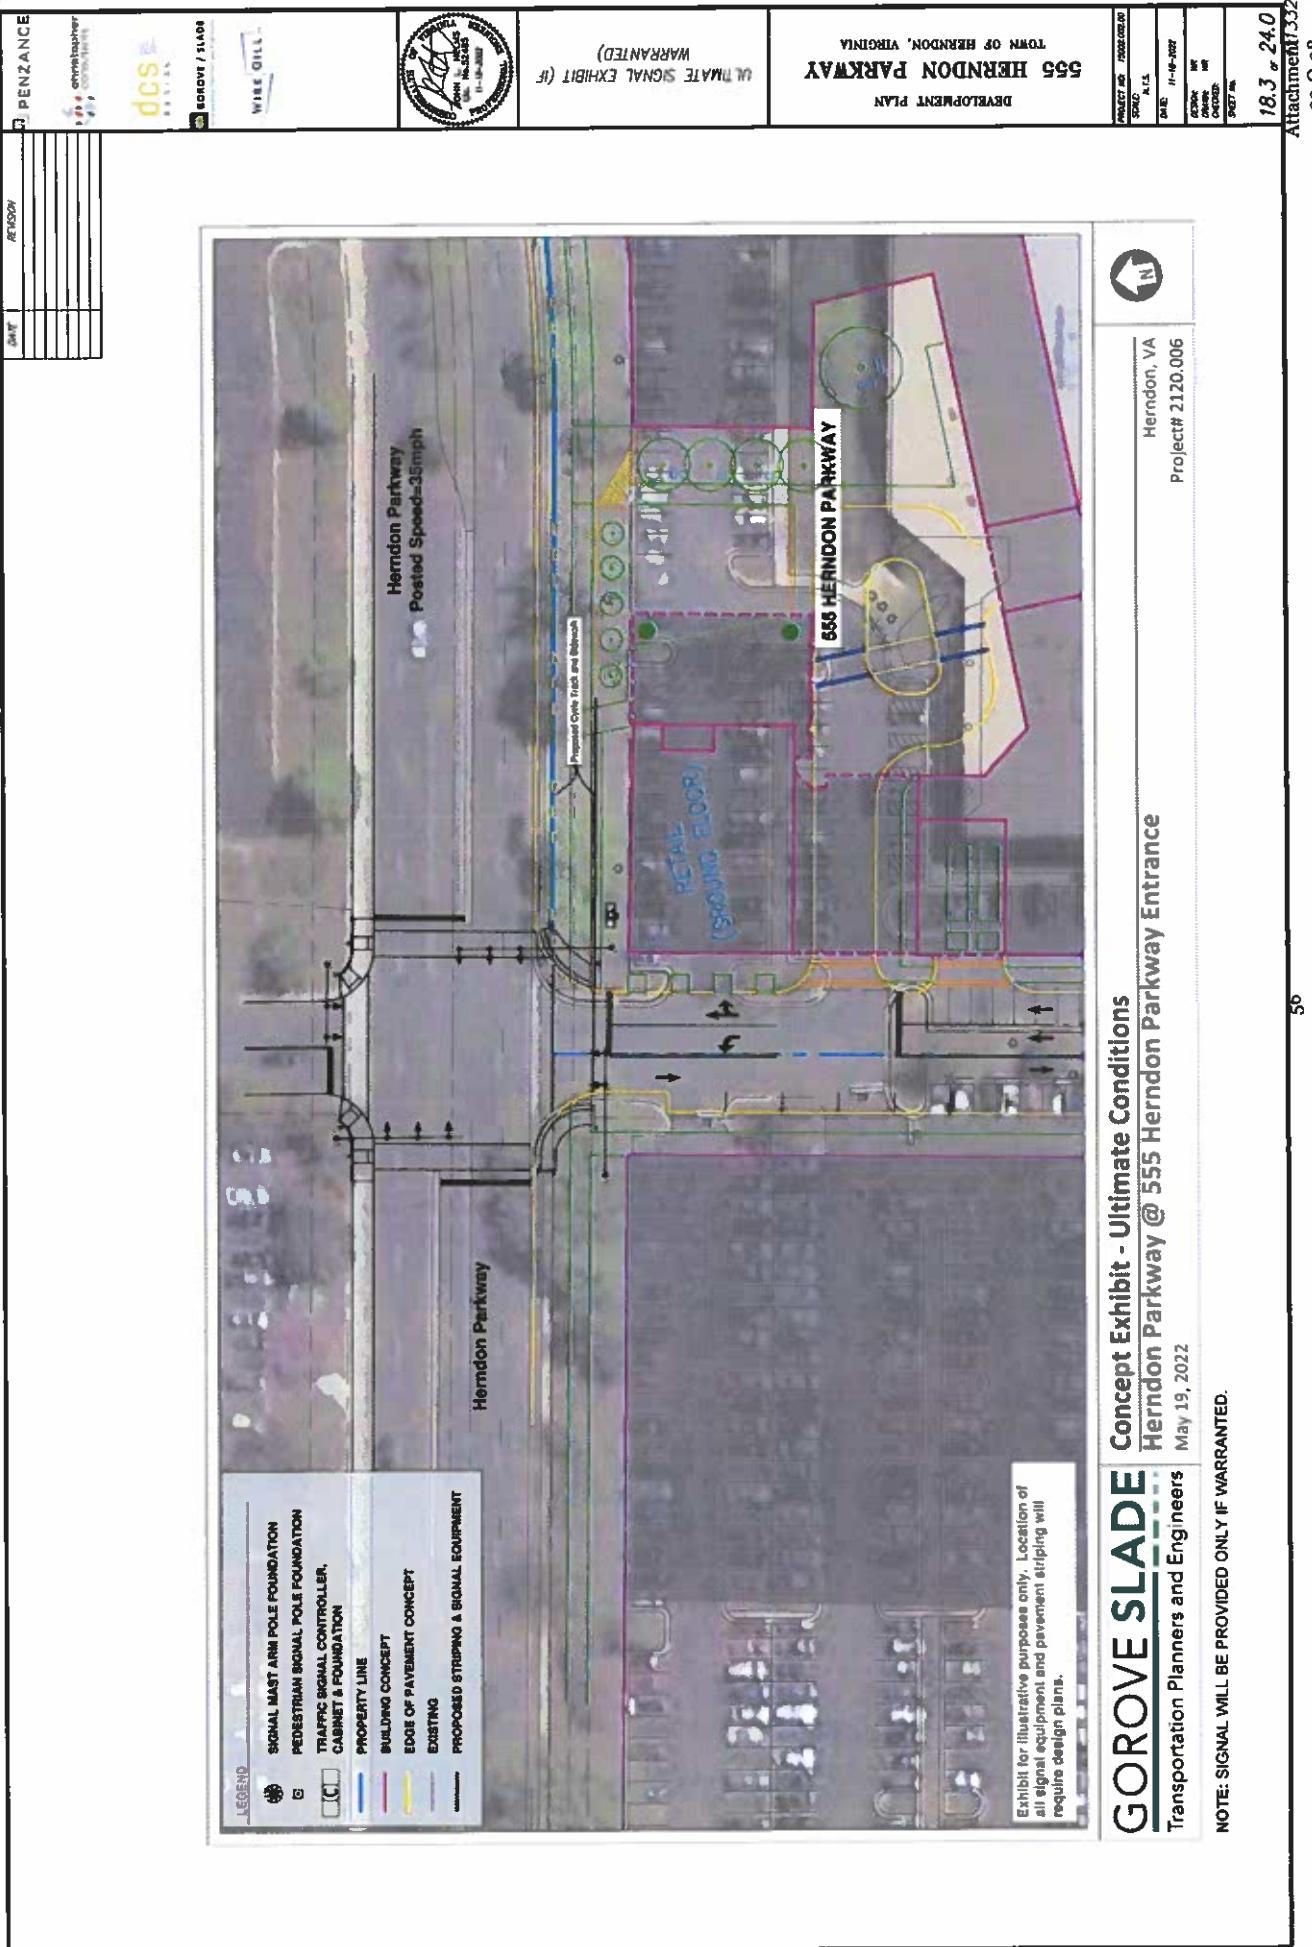

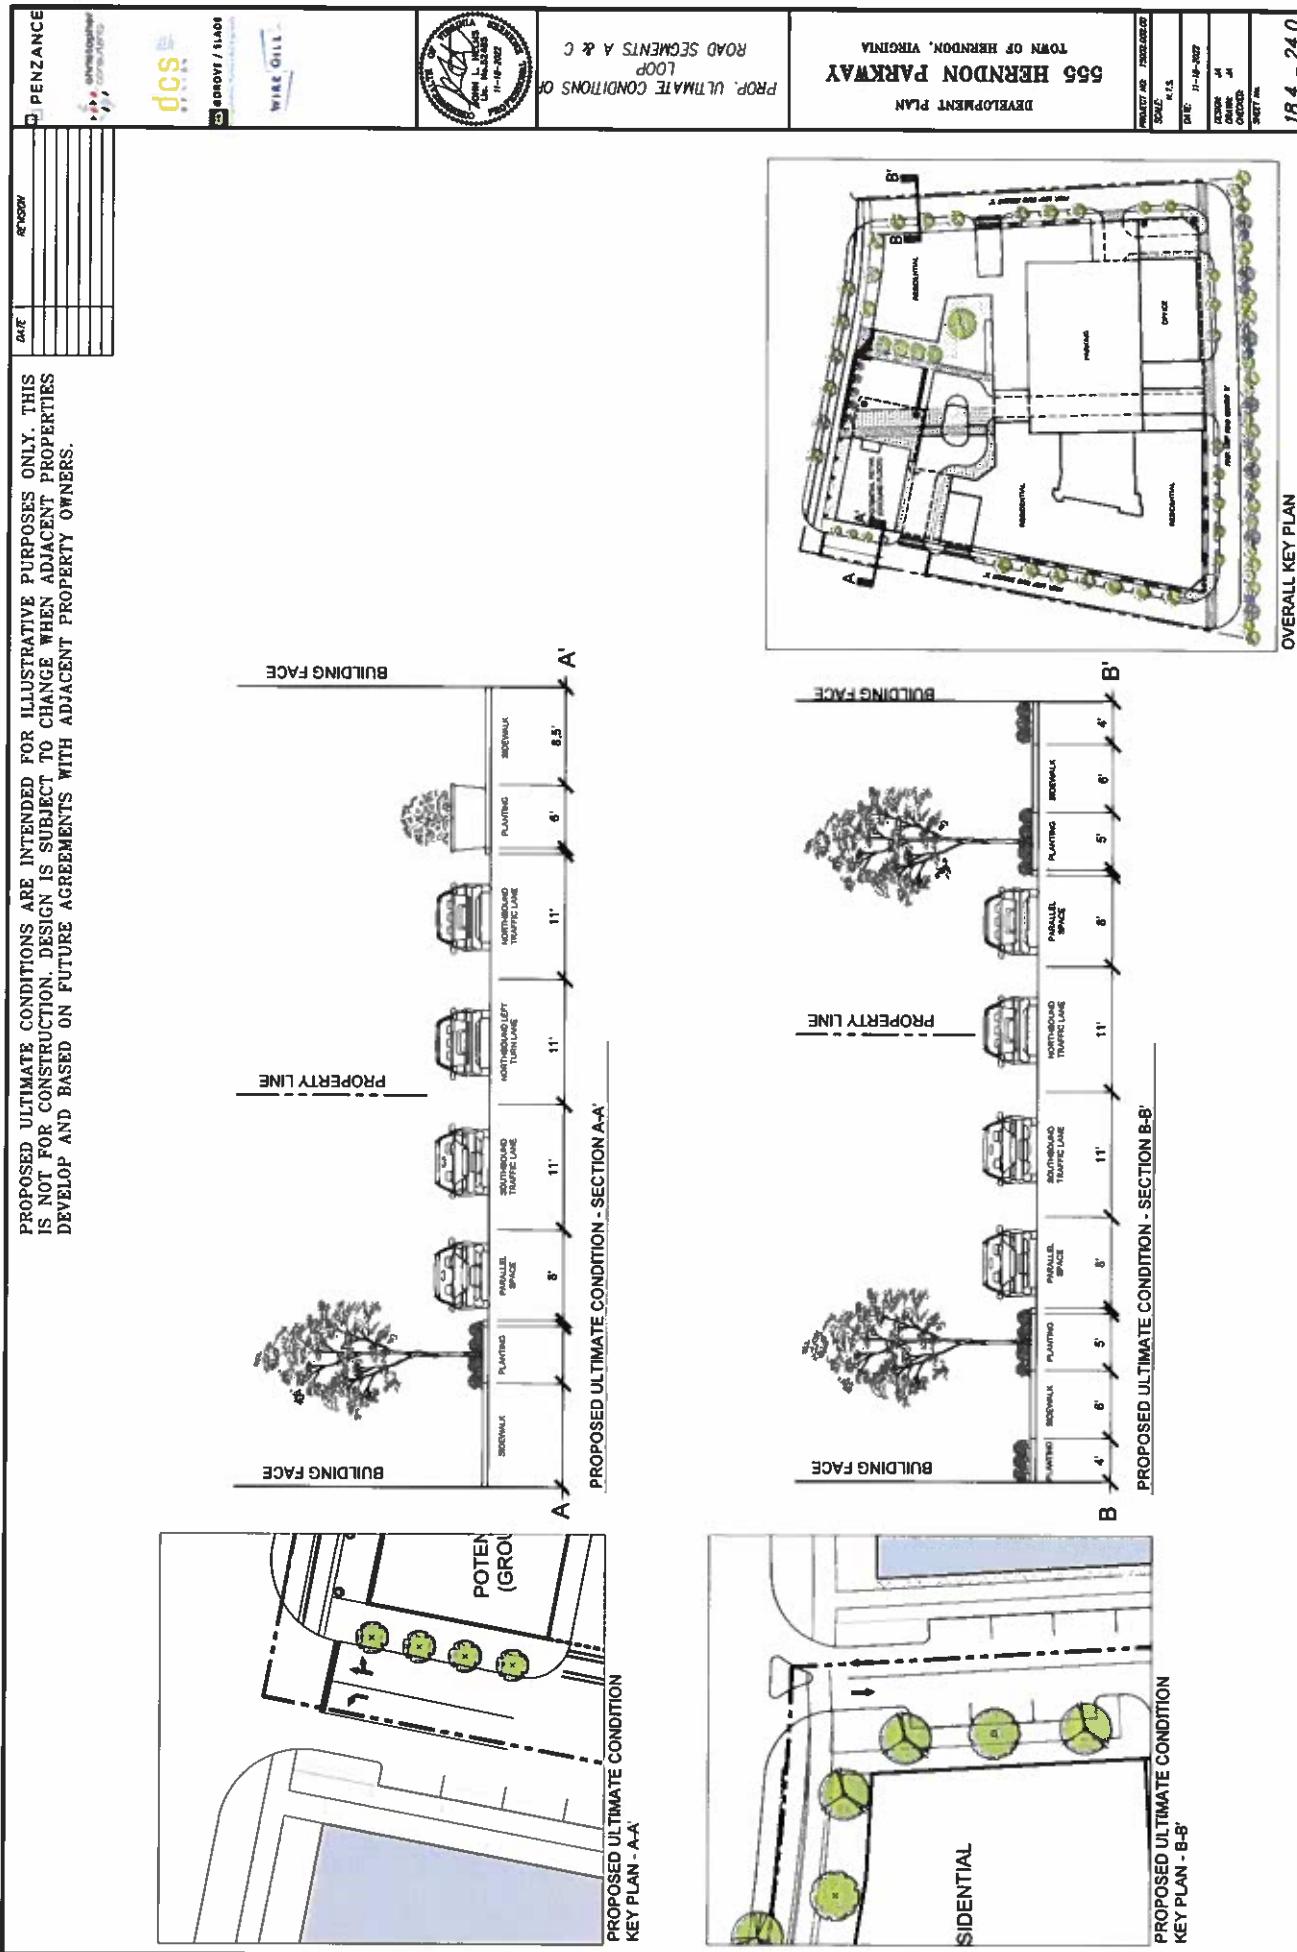

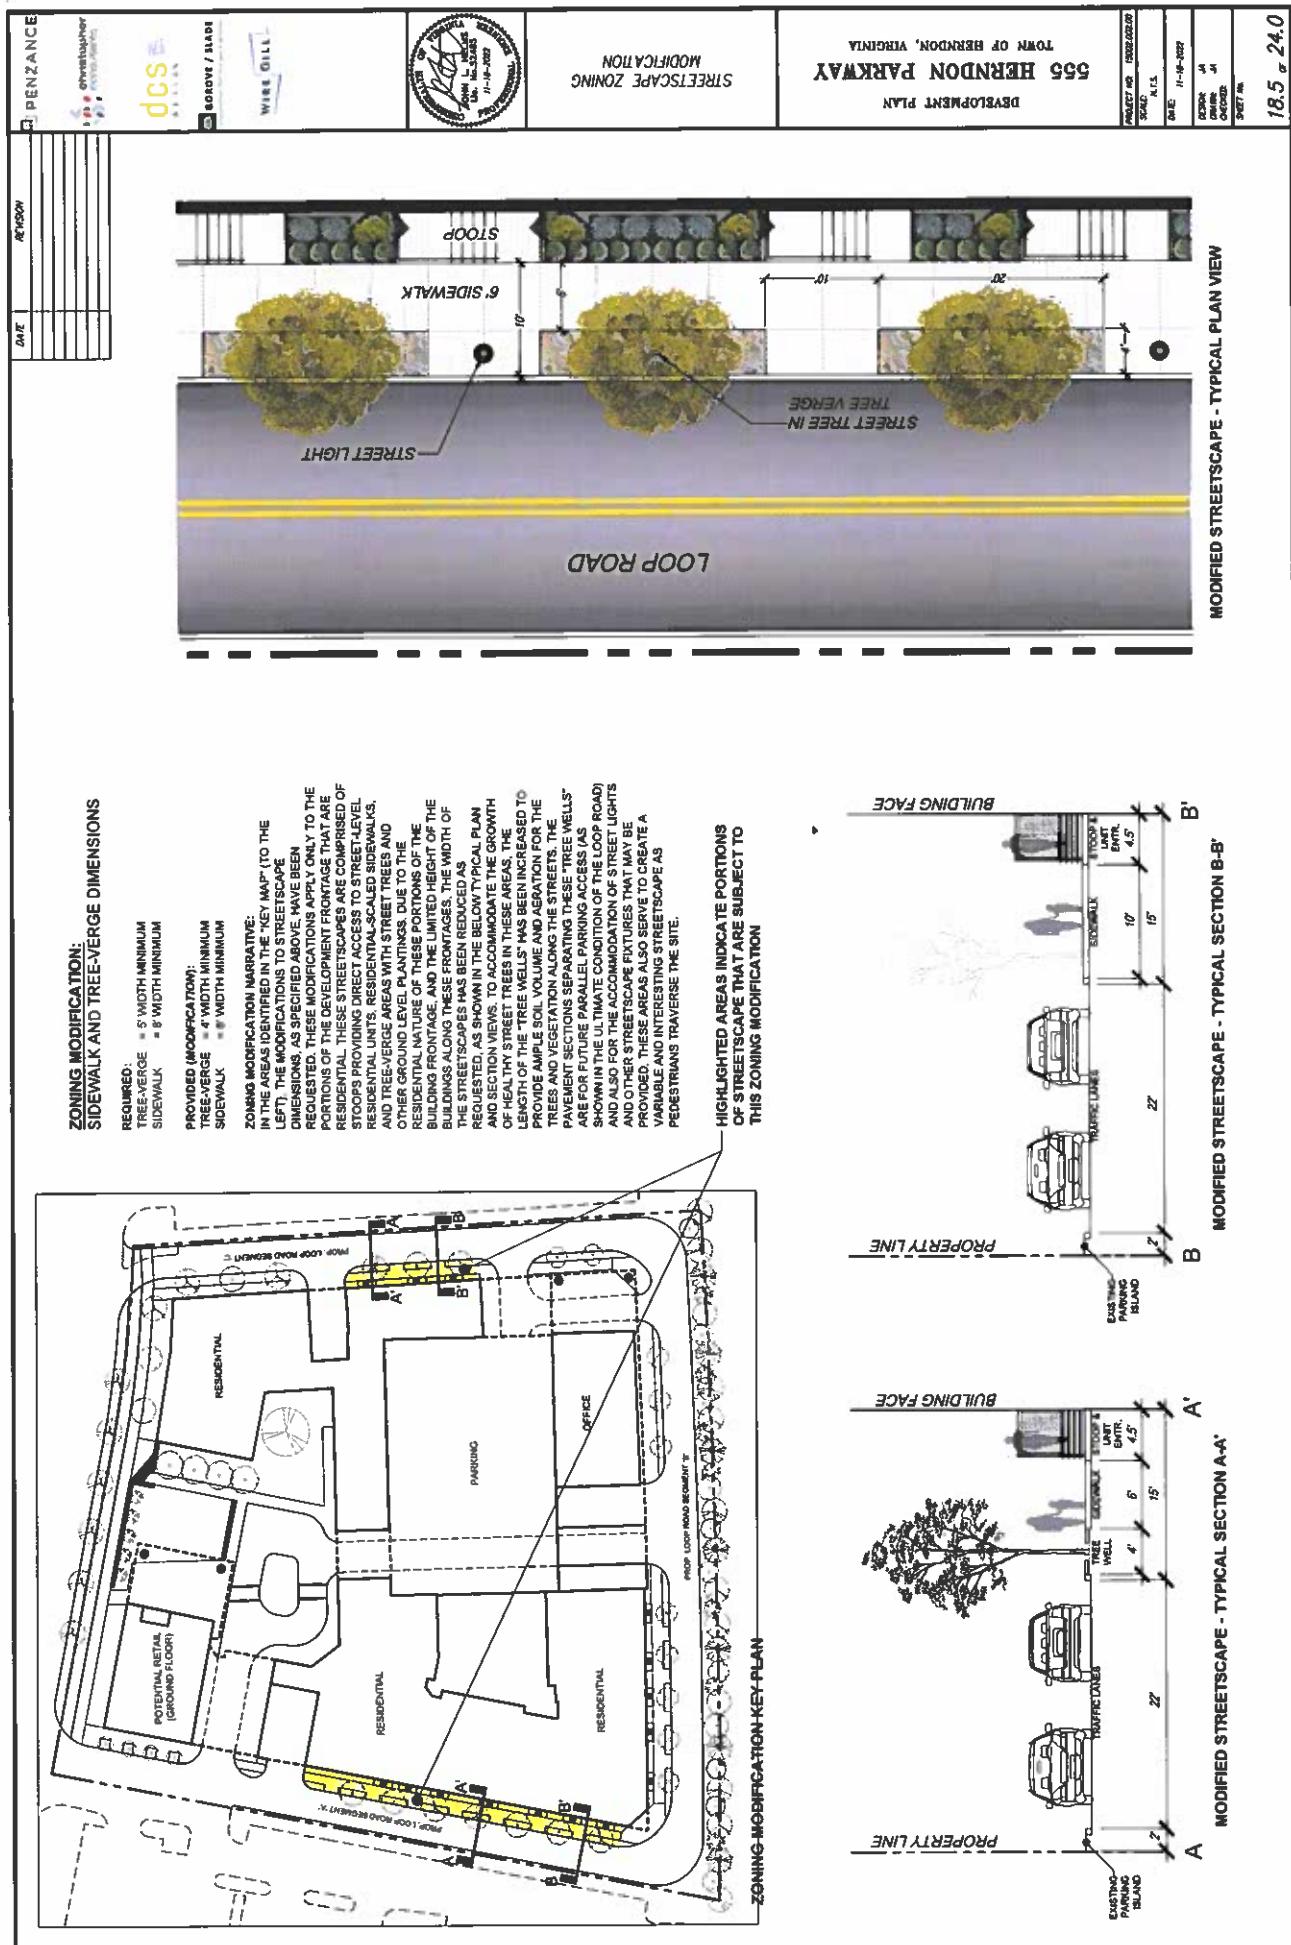
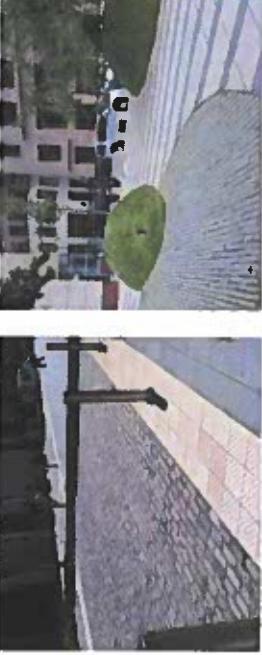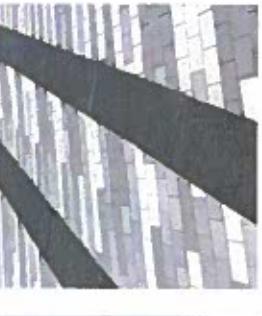
<input type="checkbox"/> PENZANCE Christopher 1000 N. Main Street 	<input type="checkbox"/> DCS GROVE / SLADE 	<input type="checkbox"/> AMENITIES 	ILLUSTRATIVE DESIGN DEVELOPMENT PLAN 365 HERNDON PARKWAY TOWN OF HERNDON, VIRGINIA	PROJECT NO. 00000000 SCALE: AS NOTED DATE: 11-06-2022 ARCHITECT: JPF DESIGNER: JPF SHEET NO. 19.0 - 24.0	
DECORATIVE PAVING EXAMPLES 		Waste Receptacle Examples 		SITE LIGHTING EXAMPLES 	
BENCH EXAMPLES 		BICYCLE RACK EXAMPLES 		THIS SHEET FOR ILLUSTRATIVE PURPOSES ONLY. DESIGNS AND FEATURES ARE SUBJECT ARB REVIEW.	
19.0 - 24.0 Attachment#332 22-O-28					

**THIS SHEET FOR ILLUSTRATIVE PURPOSES ONLY
DESIGNS AND FEATURES ARE SUBJECT A/RB REVIEW.**

Retail Sidewalk - Sidewalk goes all the way to the building to offer maximum tenant flexibility. Column planters containing fastigiate trees and a mix of perennials and shrubs between the building and sidewalk circulation space help reduce the scale of the building. The fastigiate trees provide a year-round architectural feature. The sidewalk will also better serve future parallel parking on this block. Trees are not able to be placed along the curb line due to a shallow storm water pipe in this location.



Site Elements - Areas along the perimeter road such as this marked by decorative pavers offer an opportunity for site furnishings like benches, planters, bike racks, and trash receptacles creating small "garden rooms" around the property.



Tree Wells - Street trees provided in tree wells against the curb-line. The sidewalk is placed against the building. This allows for larger-canopy street trees.



Herdon Parkway - To be planted per the revised Streetscape Manual with a mix of trees in planting strips.



East Sidewalk - Larger shade trees help reduce the scale of the architecture along this blank facade fromage. Grade is steeper and lower than the Finished Floor Elevation of the retail floor.



Illustrative Landscape - Streetwise Landscape

**55 HERNDON PARKWAY
DEVELOPMENT PLAN**

PROJECT NO: 1000000000
SCALE: AS NOTED
DATE: 11-16-2002
ICEN: 44
DRIV: 44
CROSS: 44
SWEE: 44

20.0' x 24.0'
Attachment 332
22-O-28

South Side Walk (Sugarland Run Trail Pedestrian Connection) - Medium sized shade trees, shrubs, and attractive street lighting that complements the proposed architecture helps to enhance this pedestrian travel way.



THIS SHEET FOR ILLUSTRATIVE PURPOSES ONLY.
DESIGNS AND FEATURES ARE SUBJECT ARB REVIEW.



DCS
DESIGN
CHAMBERS
CITY PLANNERS
SOLOVIA / SLATE
WALT GILL



TOWN OF HERNDON, VIRGINIA
ILLUSTRATIVE LANDSCAPE -
DEVELOPMENT PLAN

555 HERNDON PARKWAY
ILLUSTRATIVE LANDSCAPE -
DEVELOPMENT PLAN

PROJECT NO. 1000000000
SCALE AS NOTED
DATE 11-16-2022
DRAWN BY JH
CHECKED BY JH
SUPERVISOR JH

21.0 a 24.0
Attachment# 332
22-O-28



Softscape - Softer, and a more residential plant palette in a less formal planting arrangement contrasts nicely with the more geometric and regimented hardscape and architecture. Helps to bring a human scale to the plaza.



Planters - Wood grain concrete will match the seat/planter walls in the main section of the plaza. Texture matched wood used on architectural concepts and provides a "softer" and "casual" feel. Composite planters can accent entrances and bring color to facades around the remainder of the development in lieu of in-grade planters.



Seat/Planter Wall - Wood grain concrete product to hold bermed soil of planting beds and provide casual seating in addition to benches. Texture matched wood used on architectural concepts and provides a "softer" and "casual" feel. Could also be a board-form concrete or simulated stone.



Paver Intuys - Accent paving in texture and colors to match or contrast with the architecture. Options include wood-grained plank pavers, outdoor porcelain tile, or pavers slabs such as the above pictured flamed bluestone.



Feature Area - Pedestrian accessible area that can be used as an area for public art, large architectural planter, or vertical focal or themed element can be located here.



Retail Streetscape - Adequate width for circulation and dedicated areas for active space where street furniture will be located. Design of which will be based on final architectural design and door placement.



Lawn Panel - Large non-hardscaped open areas that can be programmed or non-programmed space, usually lacking desired amenity area. Turf can be natural or artificial depending on the final engineering of the structure beneath.

Plaza Overall Concept - Formal Design/Informal Materials:
A modern design language is juxtaposed with traditional materials to create an organized, functional, and accessible plaza with a more comfortable and softer human feel.

**THIS SHEET FOR ILLUSTRATIVE PURPOSES ONLY.
DESIGNS AND FEATURES ARE SUBJECT ARB REVIEW**

REVIEW ARTICLE



ON-PODIUM
PRIVATE AMENITIES




355 HERNDON PARKWAY
TOWN OF HERNDON, VIRGINIA
DEVELOPMENT PLAN

www.merriam-webster.com

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22.0 & 24.0

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22-0-28

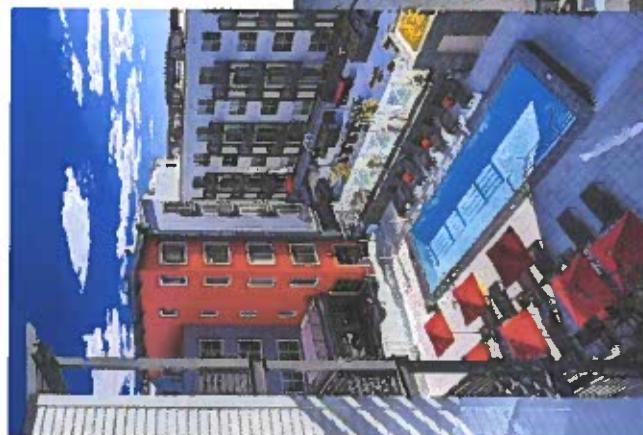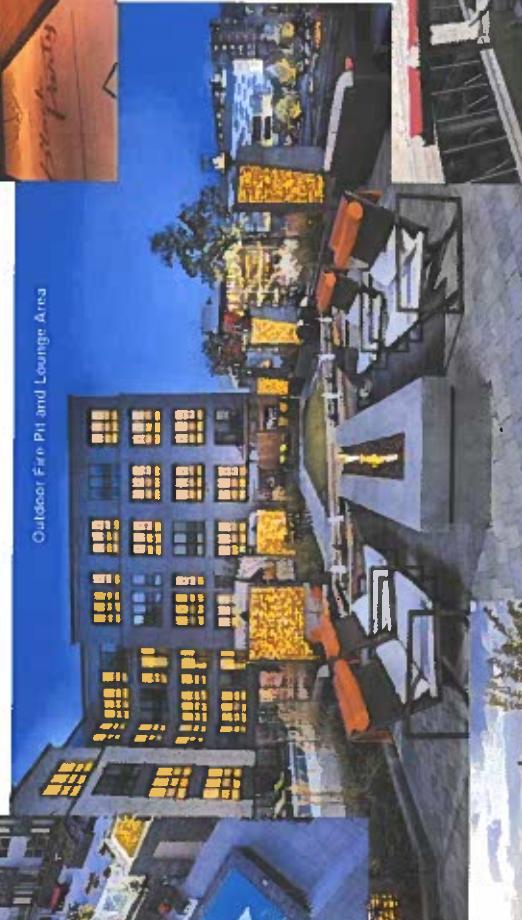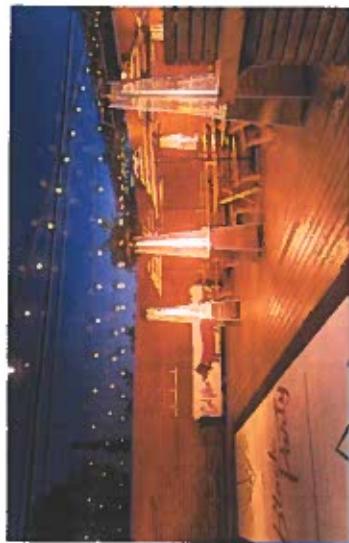

Private Amenities on Podium - Some suggested and planned amenities that may be made available to residents of the development include many features illustrated with the images on this sheet. Design is subject to the final architecture of the building.

555 HERNNDON PARKWAY
TOWN OF HERNDON, VIRGINIA
DEVELOPMENT PLAN

SUSTAINABLE PRACTICES

PROJECT NO. 555-002

AS NOTED

SCALE:

1:400-000

DATE:

1-10-2022

DESIGN:

JA

CHECKED:

JA

SHEET NO.:

04

23.0.24.0

Attachment#332

22-0-28

1. PENNANCE	2. REVISION
DATE	REVISION
7/20/2022	REV 20220720



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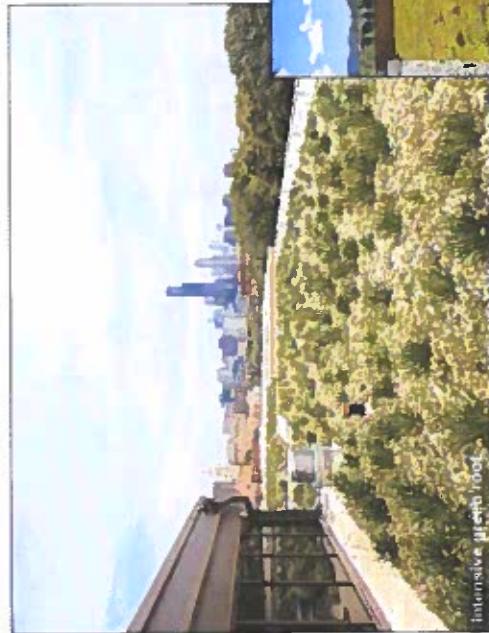
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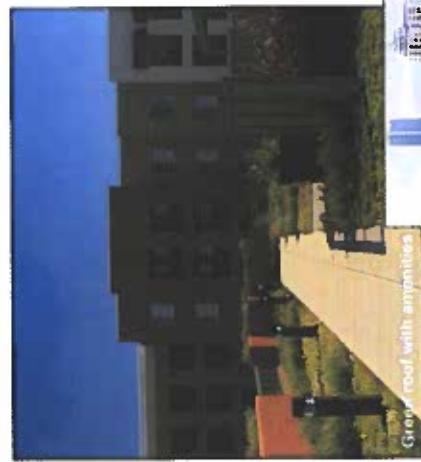
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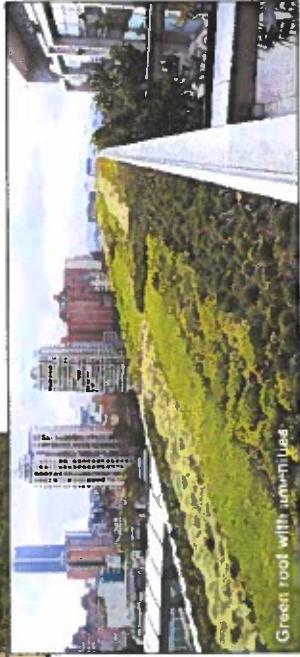
Intensive green roof




Extensive green roof



Green roof with amniotes




Green roof with uniuised

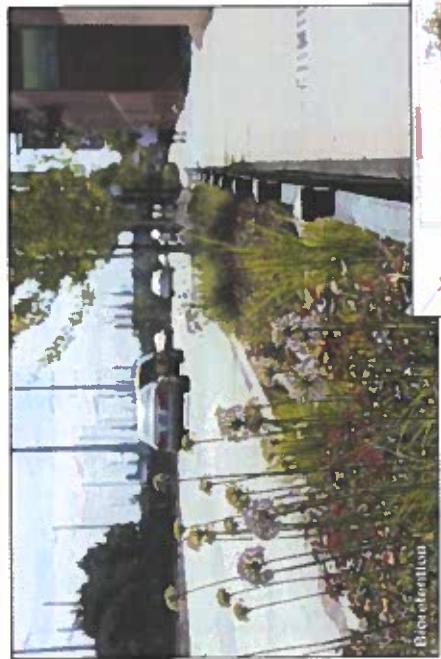

Bioretention



Erosion control

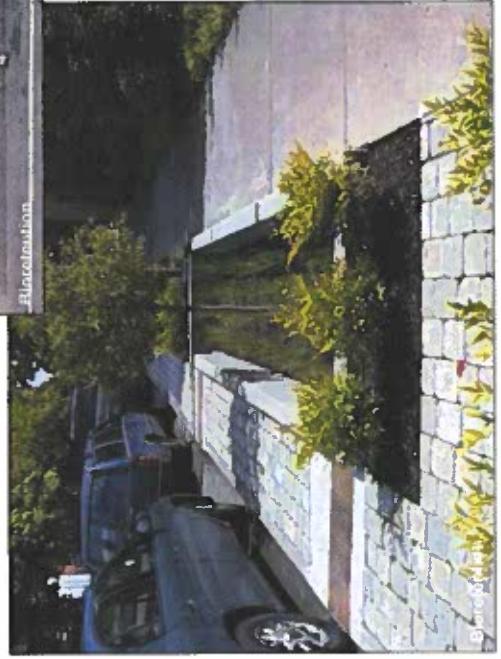

Bioswale

**SUSTAINABLE PRACTICES: THIS SHEET FOR
ILLUSTRATIVE PURPOSES ONLY. DESIGNS
AND FEATURES ARE SUBJECT TO TOWN
APPROVAL PURSUANT TO PROFER 5.e.**

